

DPW 21239 ISU: PULLING COURTS SIDING AND WINDOW REPLACEMENT

756 S. 10TH AVE POCATELLO, IDAHO 83201

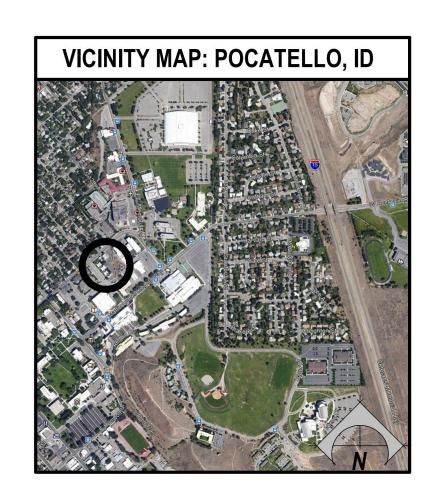


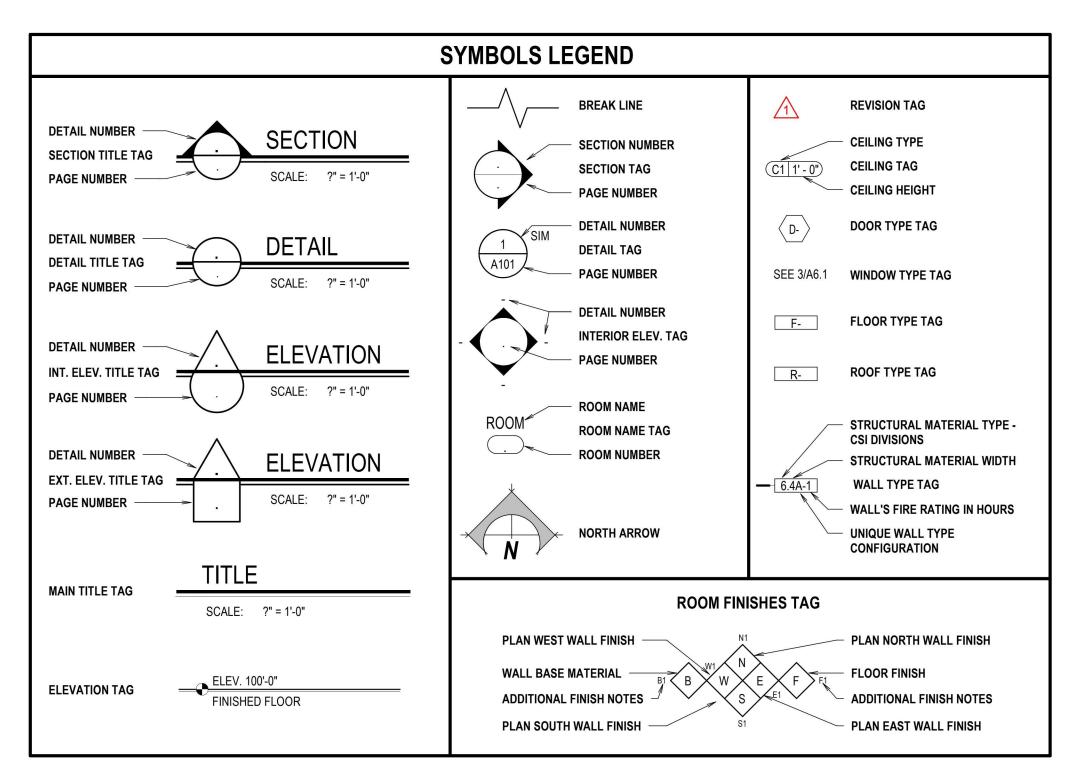

	ABBREVIATIONS
#	- NUMBER OR POUND
	- AND
AFF	- ABOVE FINISH FLOOR
	- ALUMINUM
	- ALUMINUM
	- BOTTOM OF
	- CONCRETE MASONRY UNIT
CONC.	- CONCRETE
CONT.	- CONTINUOUS
DEMO.	- CONTINUOUS - DEMOLITION OR DEMOLISH
	- DIAMETER
	- DOWN
EA.	
EIFS	- EXTERIOR INSULATION & FINISHING SYSTEM
ELEC.	- ELECTRICAL
ELEV.	- EXTERIOR INSULATION & FINISHING SYSTEM - ELECTRICAL - ELEVATION
EQ.	- EQUAL
EQUIP.	- EQUIPMENT
	- EXTERIOR
	- FINISH FLOOR
	- FIBERGLASS REINFORCED PLASTIC
GA	- GAUGE
GYP.	- GYPSUM
	- HOLLOW METAL
	- HOUR
HVAC	- HEATING, VENTILATING, & AIR CONDITION
I.D.	- INSIDE DIAMETER
I.M.P.	- INSIDE DIAMETER - INSULATED METAL PANEL - INSULATION
INSUL.	
	- INTERIOR
	- MAXIMUM
	- MECHANICAL
MFR	- MANUFACTURER
MIN.	- MINIMUM - NOT IN CONTRACT
	- NUMBER
	- ON CENTER
	- OUTSIDE DIAMETER
PLY PLUM.	- PLYWOOD - PLUMBING
PLUM. PVC	- PLUMBING - POLYVINYL CHLORIDE
	- REFLECTED CEILING PLAN
	- REPLECTED CEILING PLAN - REQUIRED
	- SIMILAR
	- SINGLE PLY MEMBRANE
	- STORAGE
	- STRUCTURAL
	- TOP OF
	- TYPICAL
	- UNLESS NOTED OTHERWISE
W/	- WITH
	- WATER CLOSET
WD.	- WOOD

DRAWING INDEX						
GENERAL						
G1.0	GENERAL INFORMATION					
ARCHITECTU	JRAL					
A1.1	DEMOLITION PLANS BUILDINGS A & H					
A1.2	DEMOLITION PLANS BUILDINGS B,C,D,E,F,G,I,J					
A1.3	DEMOLITION ELEVATIONS					
A2.1	FLOOR PLANS BUILDINGS A & H					
A2.2	FLOOR PLANS BUILDINGS B,C,D,E,F,G,I,J					
A3.1	BUILDING ELEVATIONS					
A4.1	BUILDING SECTIONS					
A5.1	DETAILS					
A5.2	DETAILS					
A6.1	WINDOW DETAILS					


BUILDING CODE: IBC 2018

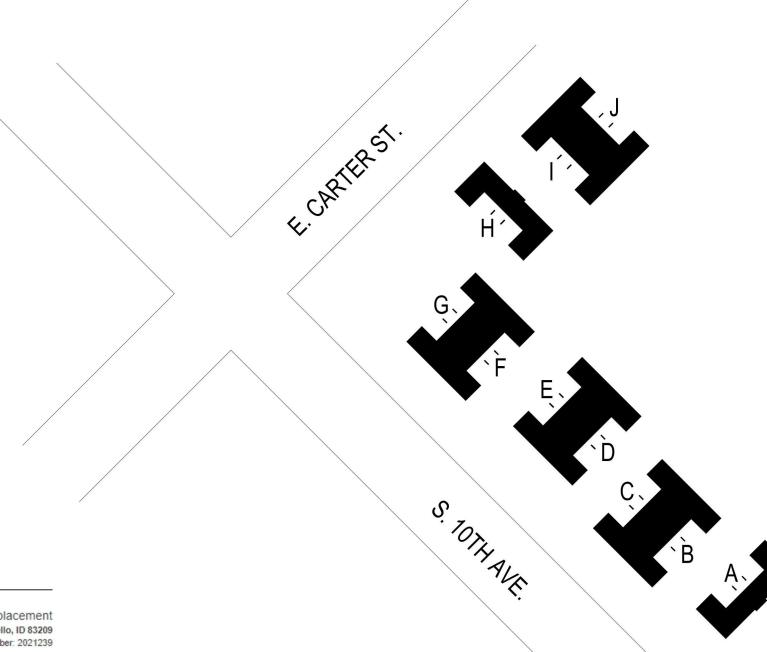

Agency Construction Approval No. 1 for project 2021239 ISU: Pulling Courts Housing Siding & Window Replacement

Created by: Martin Santoyo on 25-Aug-2021 Last Modified by: Martin Santoyo on 25-Aug-2021

2021239 ISU: Pulling Courts Housing Siding & Window Replacement Project Number: 2021239

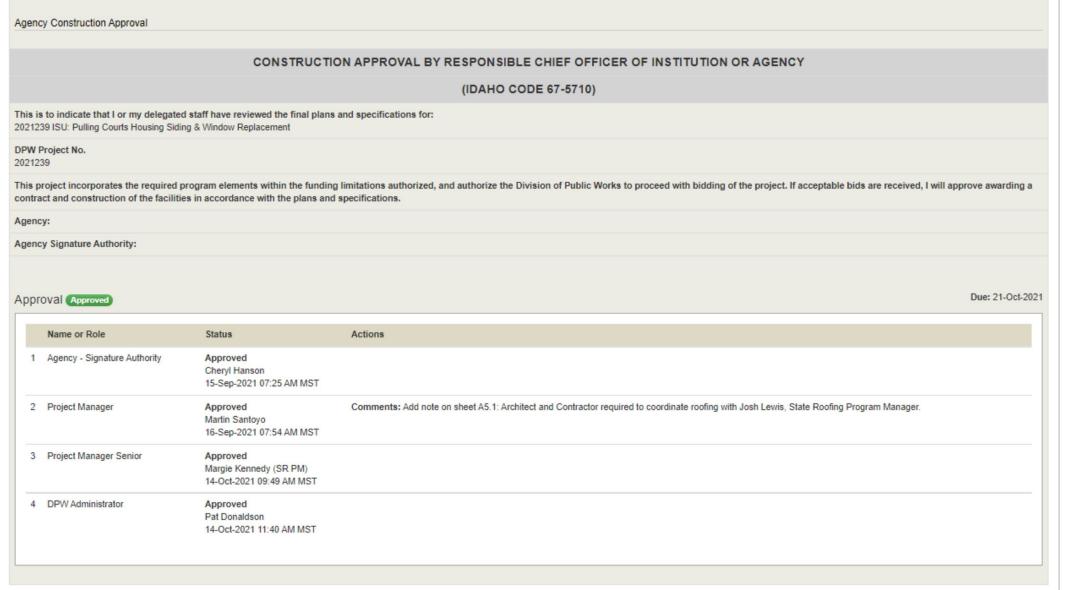

N	SITE REFERENCE PLAN
, 1	SCALE: 1" = 60'-0"

JG AND WINDOW REPL

21239 ISU:


REVISIONS


PROJECT NO.

AUGUST 2021

DRAWN BY:

CHECKED BY:

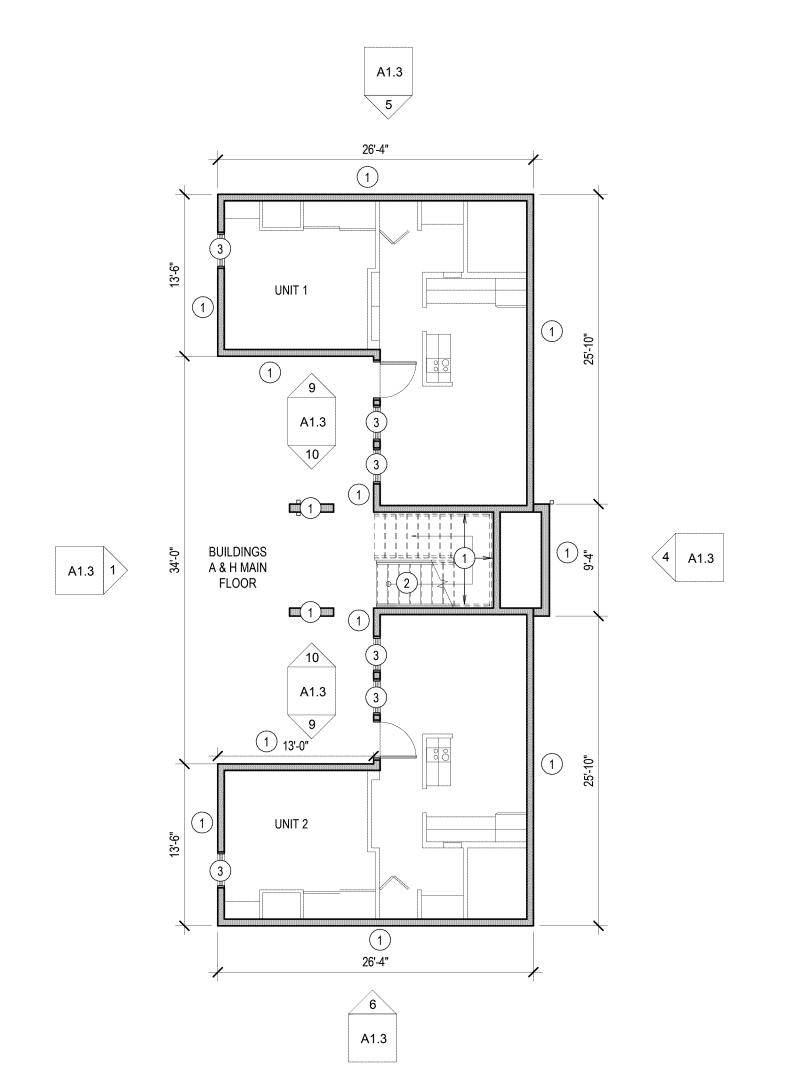

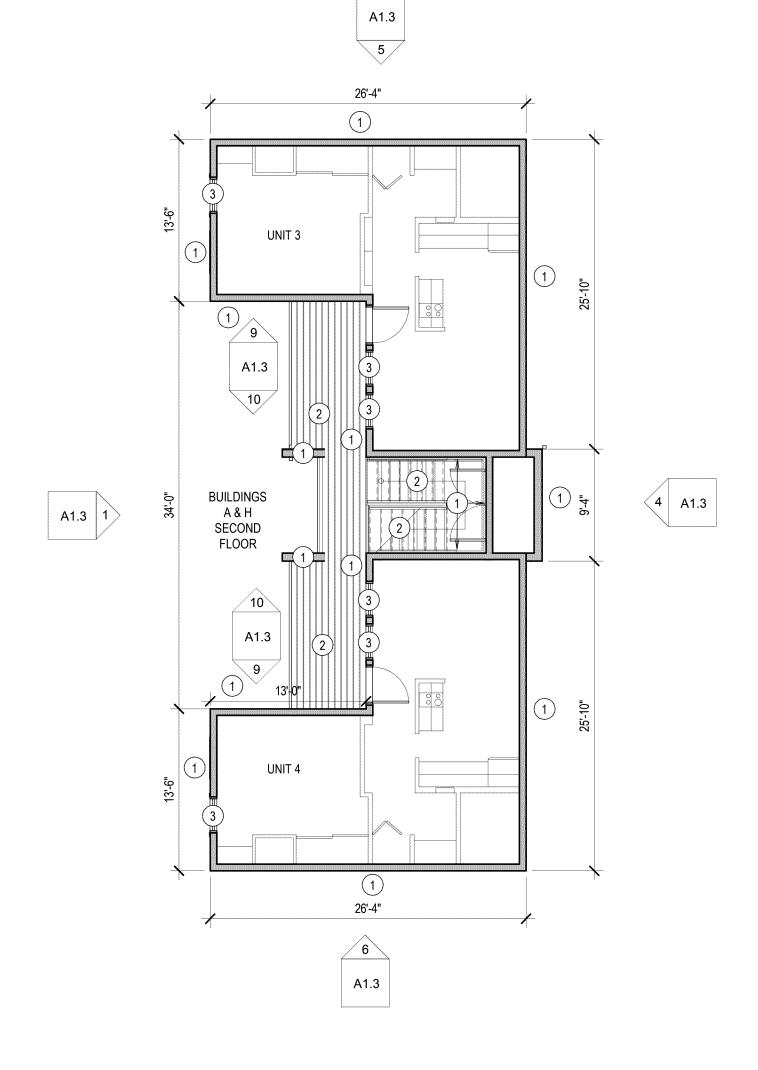

MAIN LEVEL DEMOLITION PLAN

SCALE: 1/8" = 1'-0"

SECOND LEVEL DEMOLITION PLAN

SCALE: 1/8" = 1'-0"

DEMOLITION GENERAL NOTES

- CONTRACTOR SHALL RESOLVE ALL DIMENSIONAL OR OTHER DISCREPANCIES, DURING LAYOUT WITH ARCHITECT, PRIOR TO BEGINNING CONSTRUCTION.
- WORK TO BE IN ACCORDANCE WITH CODES & ACCESSIBILITY REQUIREMENTS.
- CONTRACTOR TO REMOVE ITEMS THAT ARE ATTACHED TO, OR IMPEDE THE REMOVAL OF, THE EXISTING WOOD SIDING, TRIM AND WEATHER BARRIER, WITH THE EXCEPTION OF THE STAIRS, DECK, HANDRAILS AND SOFFIT. THESE INCLUDE, BUT ARE NOT LIMITED TO; CONDUIT, VENTS, GUTTERS, DOWNSPOUTS, PIPING, HOSE BIBBS, AIR CONDITIONERS, LIGHTS, HOSE HANGERS, BUILDING SIGNAGE, MECHANICAL UNITS, ROOF CAP/DRIP EDGE, DOOR/WINDOW TRIM, SCUPPERS, CHAIN LINK FENCE POSTS, AND WIRES.
- THE AGENCY HAD A SERVICE CONTRACTOR REVIEW THE CONDITION OF THE THE EXISTING WOOD SIDING. IT WAS NOTED THAT BEHIND THE EXISTING WOOD SIDING IS BUILDING PAPER AND WOOD SHEATHING. THEREFORE IT IS ANTICIPATED THAT EXISTING BUILDING PAPER AND WOOD SHEATHING WILL BE FOUND BEHIND THE EXISTING WOOD SIDING.
- 5. USE ISOLATION TAPE BETWEEN DIS-SIMILAR METALS.
- DISCONNECT AND REMOVE ITEMS THAT PENETRATE THE EXISTING SIDING, SO NEW SIDING CAN BE INSTALLED WITHOUT COMPLICATION. THIS INCLUDES, BUT IS NOT LIMITED TO; CONDUIT, WIRING, PIPING, VENTS, HOSE
- PENETRATIONS TO BE SEALED AND WATERPROOFED.
- REPLACE ANY EXISTING WALL SHEATHING THAT IS DAMAGED, DETERIORATED OR DESTROYED.

DEMOLITION KEYNOTES

- REMOVE WOOD SIDING, TRIM AND WEATHER BARRIER. CAREFULLY REMOVE ANYTHING ATTACHED TO THE SIDING THAT IMPEDES ITS REMOVAL, WITH THE EXCEPTION OF THE STAIRS AND RAILING AND DECK.
- REMOVE WINDOW AND TRIM. REMOVE WOOD SILL ON THE INTERIOR OF
- WINDOW. CUT BACK AND MODIFY GYPSUM SURROUND AS NEEDED TO INSTALL NEW WINDOW. SEE SHEET A6.1 FOR DETAILS

RETAIN AND PROTECT EXTERIOR DECK, RAILING AND STAIRS.

- RETAIN AND PROTECT METAL RAILING AND WALL MOUNTED BRACKETS AT
- (5) REMOVE GUTTERS, DOWNSPOUTS AND SCUPPERS
- (6) REMOVE PARAPET CAPS.
- EXISTING MEMBRANE ROOFING TO BE CUT BACK AT THESE LOCATIONS TO ALLOW NEW SIDING TO BE INSTALLED. NEW MEMBRANE ROOFING TO OVERLAP EXISTING MEMBRANE ROOFING, SEE DETAILS ON SHEET A6.1
- (8) REMOVE EXISTING EXHAUST VENT CAP
- 9) REMOVE EXISTING WALL LOUVER

REHITECTURE/


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DEMOLITION PLANS B

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DPW 21239 ISU:

21001 AUGUST 2021 DRAWN BY: CHECKED BY:



MAIN LEVEL DEMOLITION PLAN

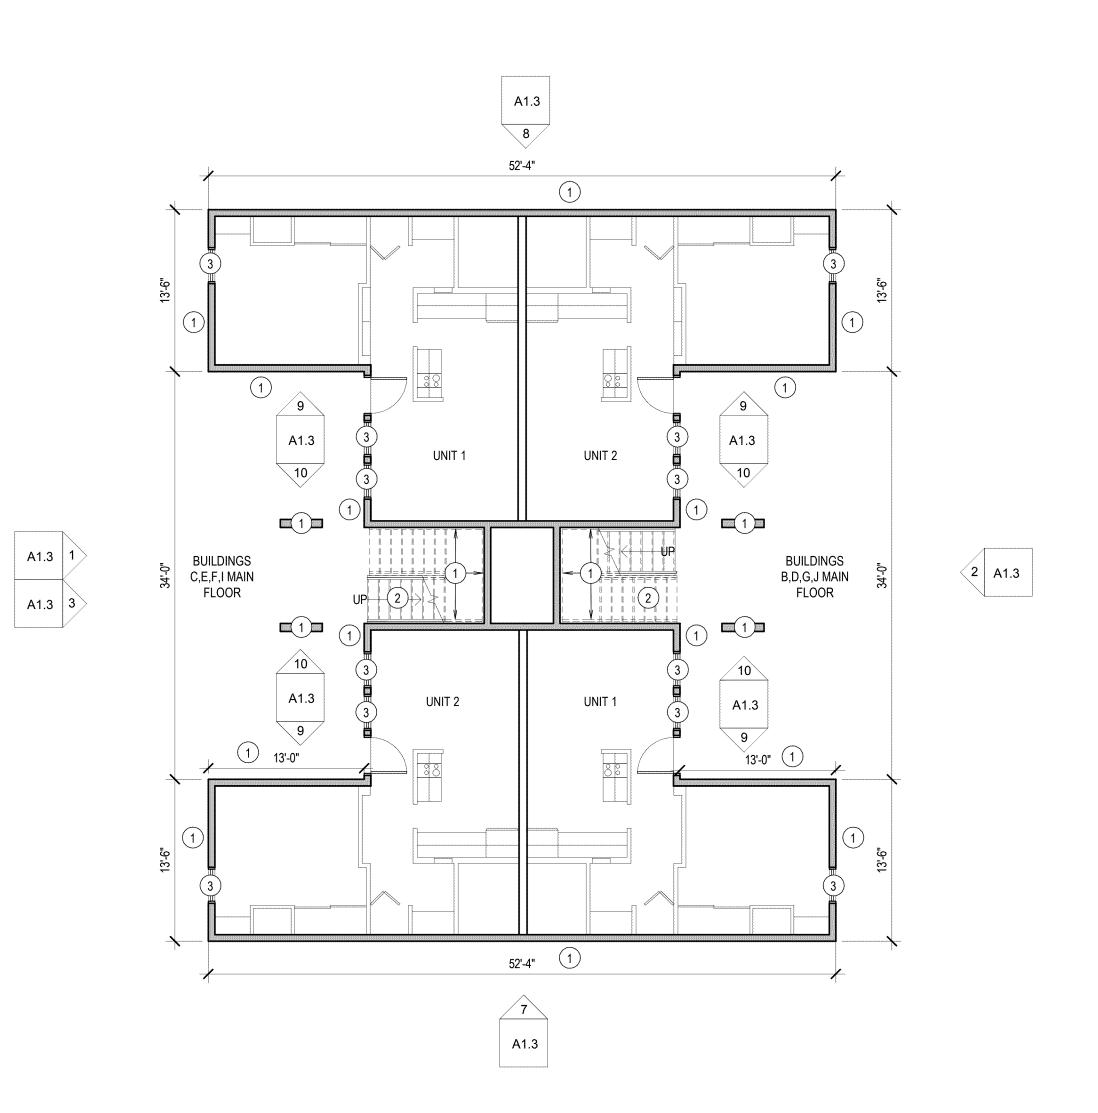SCALE: 1/8" = 1'-0"

52'-4" /9\ A1.3 UNIT 3 UNIT 4 10/ BUILDINGS BUILDINGS C,E,F,I SECOND B,D,G,J SECOND FLOOR FLOOR 52'-4"

SECOND LEVEL DEMOLITION PLAN

SCALE: 1/8" = 1'-0"

DEMOLITION GENERAL NOTES

- CONTRACTOR SHALL RESOLVE ALL DIMENSIONAL OR OTHER DISCREPANCIES, DURING LAYOUT WITH ARCHITECT, PRIOR TO BEGINNING CONSTRUCTION.
- WORK TO BE IN ACCORDANCE WITH CODES & ACCESSIBILITY REQUIREMENTS.
- CONTRACTOR TO REMOVE ITEMS THAT ARE ATTACHED TO, OR IMPEDE THE REMOVAL OF, THE EXISTING WOOD SIDING, TRIM AND WEATHER BARRIER, WITH THE EXCEPTION OF THE STAIRS, DECK, HANDRAILS AND SOFFIT. THESE INCLUDE, BUT ARE NOT LIMITED TO; CONDUIT, VENTS, GUTTERS, DOWNSPOUTS, PIPING, HOSE BIBBS, AIR CONDITIONERS, LIGHTS, HOSE HANGERS, BUILDING SIGNAGE, MECHANICAL UNITS, ROOF CAP/DRIP EDGE, DOOR/WINDOW TRIM, SCUPPERS, CHAIN LINK FENCE POSTS, AND WIRES.
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- 5. USE ISOLATION TAPE BETWEEN DIS-SIMILAR METALS.
- DISCONNECT AND REMOVE ITEMS THAT PENETRATE THE EXISTING SIDING, SO NEW SIDING CAN BE INSTALLED WITHOUT COMPLICATION. THIS INCLUDES, BUT IS NOT LIMITED TO; CONDUIT, WIRING, PIPING, VENTS, HOSE

PENETRATION FINANCIES

- REELACE WYSEXISTING WALL SHEATHING LEW BARRIEM CAREFULLY PREMOVE ANYTHING ATTACHED TO THE SIDING THAT IMPEDES ITS
- RETAIN AND PROTECT EXTERIOR DECK, RAILING AND STAIRS.
- REMOVE WINDOW AND TRIM. REMOVE WOOD SILL ON THE INTERIOR OF WINDOW. CUT BACK AND MODIFY GYPSUM SURROUND AS NEEDED TO INSTALL NEW WINDOW. SEE SHEET A6.1 FOR DETAILS
- RETAIN AND PROTECT METAL RAILING AND WALL MOUNTED BRACKETS AT
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- (8) REMOVE EXISTING EXHAUST VENT CAP
- 9 REMOVE EXISTING WALL LOUVER

A B C H I T E C T U R E / P L A N N I GOO JOHN ADAMS PARKWAY / P.O. BOX 2212 / 101 (P) 208.522.8779 (F) 208.522.8785 (

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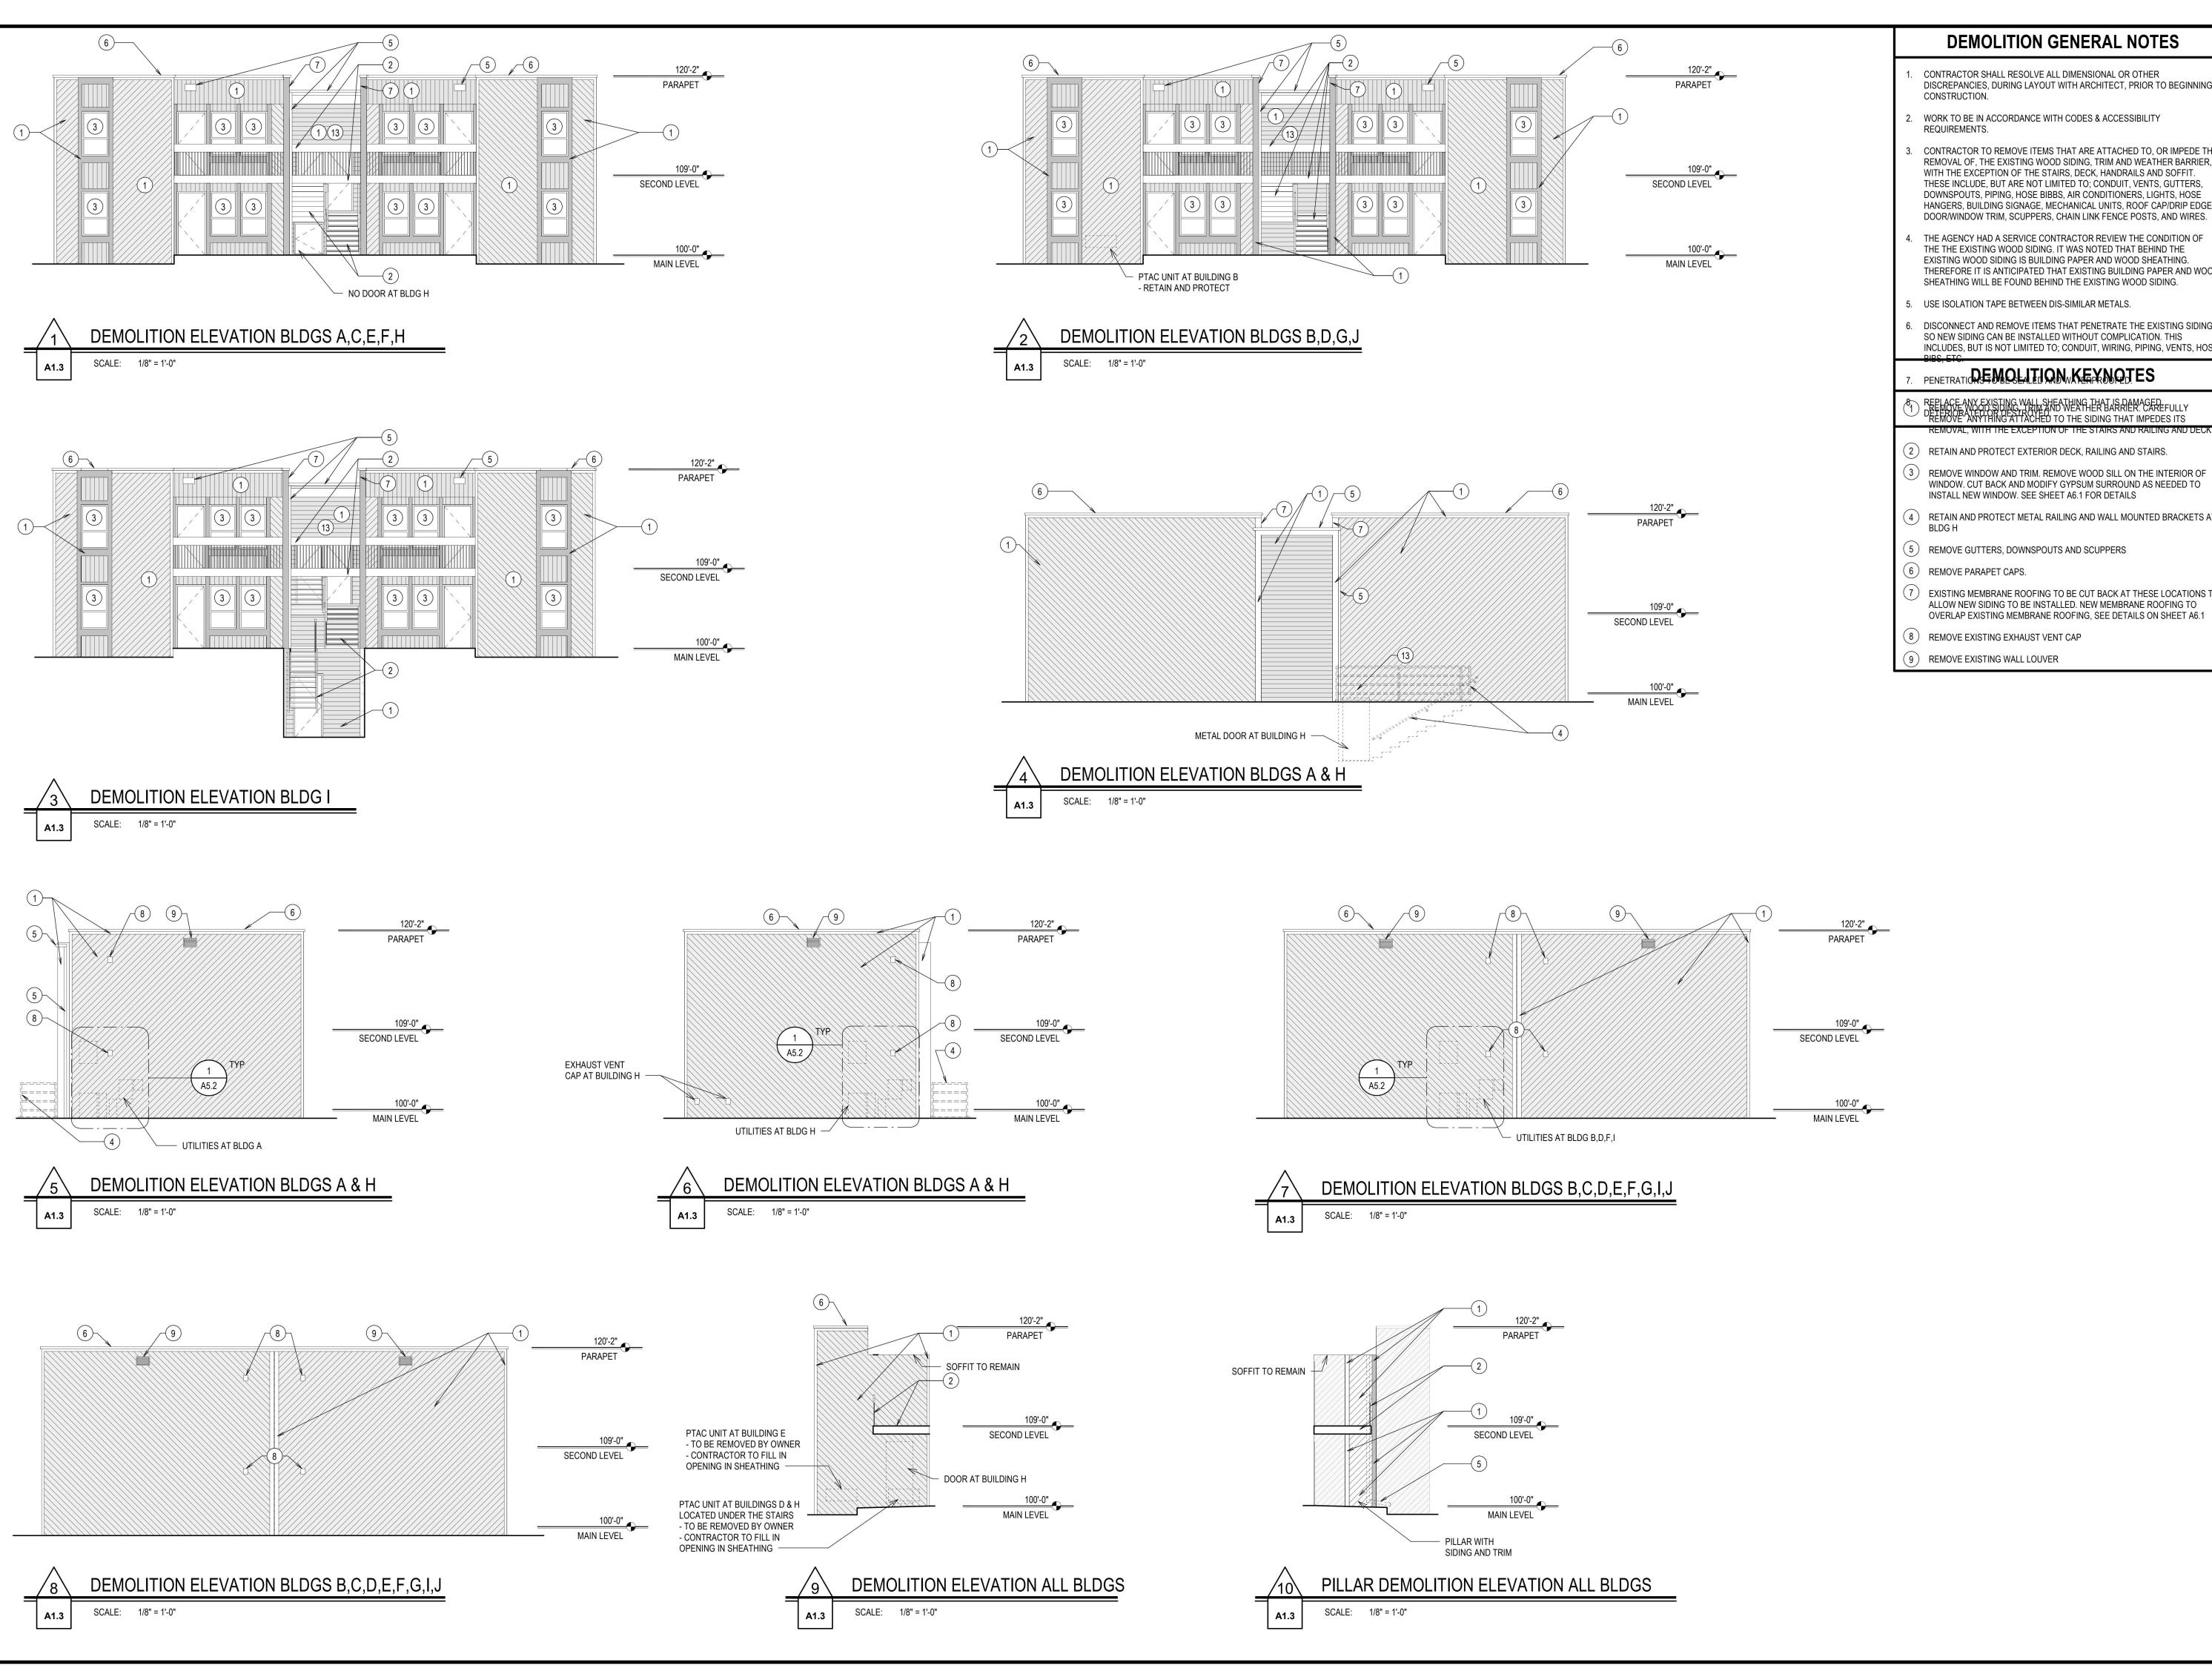
AND WINDOW

): PULLING COURTS SIDING 756 S. 10TH / POCATELLO, IDAH BUILD

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DPW 21239 ISU:

AUGUST 2021 CHECKED BY:



WORK TO BE IN ACCORDANCE WITH CODES & ACCESSIBILITY

CONTRACTOR TO REMOVE ITEMS THAT ARE ATTACHED TO, OR IMPEDE THE REMOVAL OF, THE EXISTING WOOD SIDING, TRIM AND WEATHER BARRIER, WITH THE EXCEPTION OF THE STAIRS, DECK, HANDRAILS AND SOFFIT. THESE INCLUDE, BUT ARE NOT LIMITED TO; CONDUIT, VENTS, GUTTERS, DOWNSPOUTS, PIPING, HOSE BIBBS, AIR CONDITIONERS, LIGHTS, HOSE HANGERS, BUILDING SIGNAGE, MECHANICAL UNITS, ROOF CAP/DRIP EDGE, DOOR/WINDOW TRIM, SCUPPERS, CHAIN LINK FENCE POSTS, AND WIRES.

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PENETRATION FINANCIES

- RELACE ANX EXISTING WALL SHEATHEN THAT ARRIEM CEREFULLY REMOVE ANYTHING ATTACHED TO THE SIDING THAT IMPEDES ITS
- RETAIN AND PROTECT EXTERIOR DECK, RAILING AND STAIRS.
- REMOVE WINDOW AND TRIM. REMOVE WOOD SILL ON THE INTERIOR OF WINDOW. CUT BACK AND MODIFY GYPSUM SURROUND AS NEEDED TO INSTALL NEW WINDOW. SEE SHEET A6.1 FOR DETAILS
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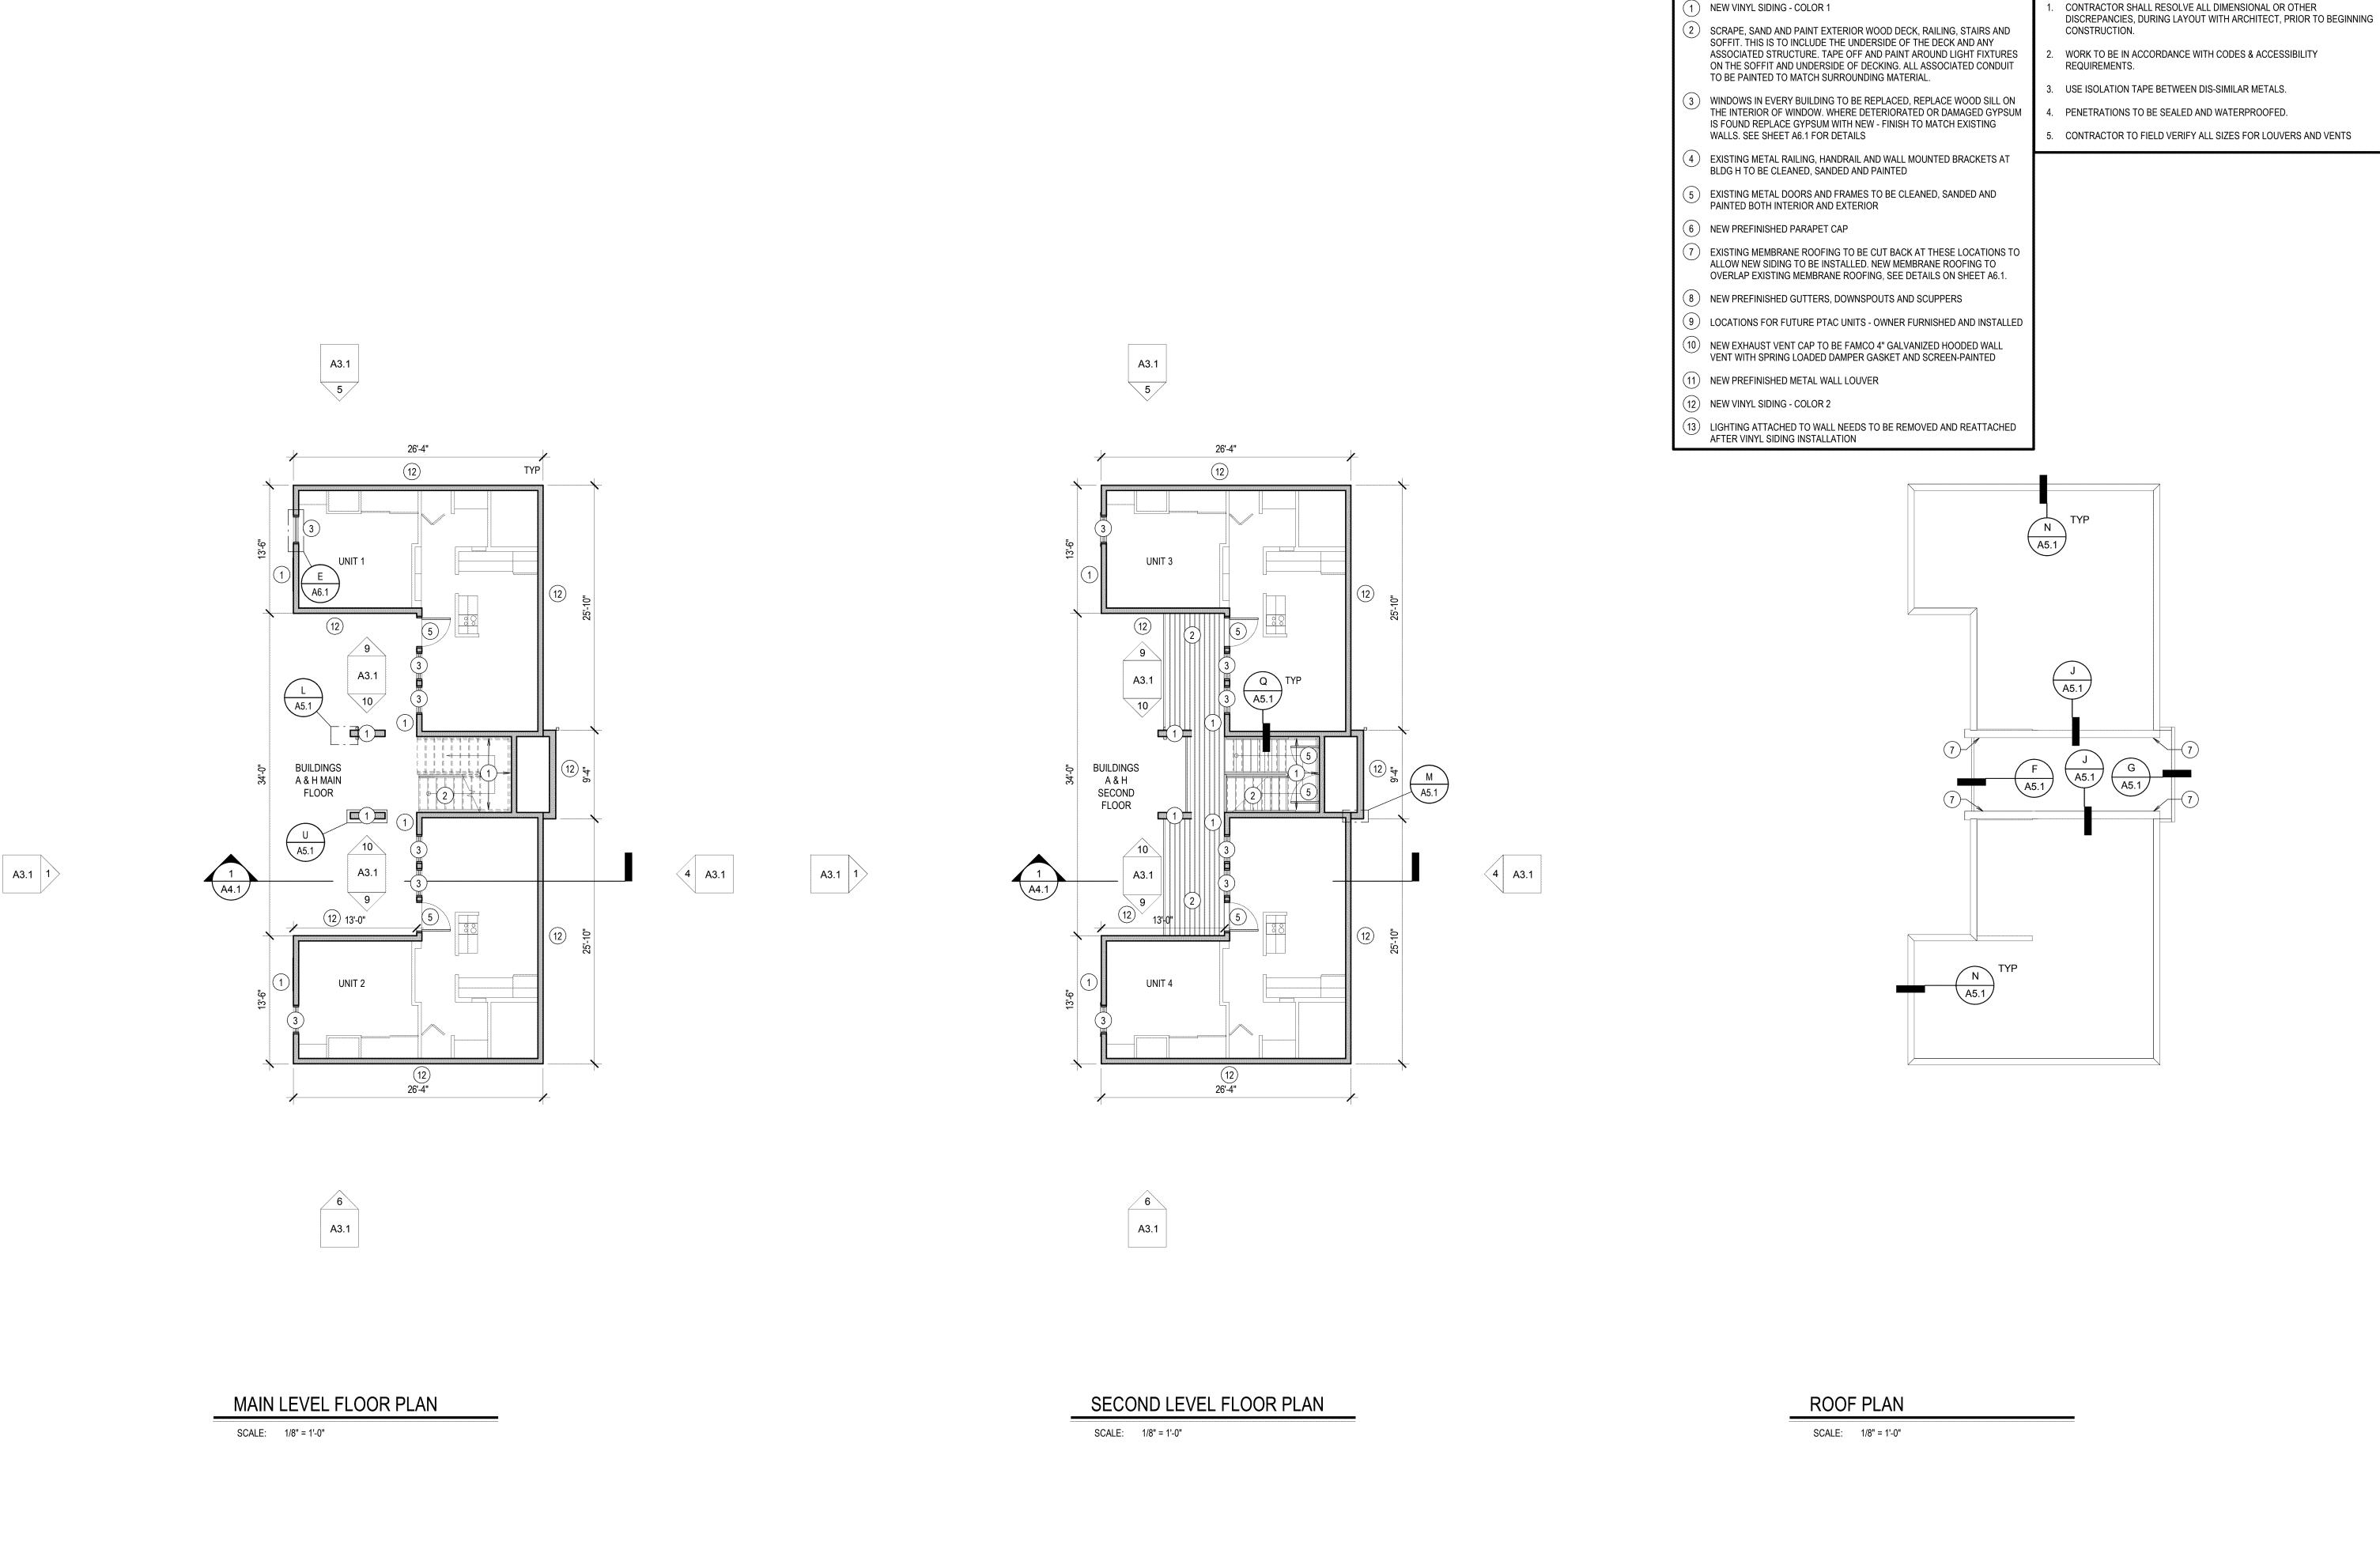
AND WINDOW AVE AHO 83201

J: PULLING COURTS SIDING 756 S. 10TH / POCATELLO, IDAH DEMOLITION

DPW 21239 ISU:

REVISIONS

PROJECT NO. 21001 DATE: AUGUST 2021 DRAWN BY: **NBW CHECKED BY:** NBW



GENERAL NOTES

WORK TO BE IN ACCORDANCE WITH CODES & ACCESSIBILITY

KEYNOTES


AND WINDOW REPL

DPW 21239 ISU: PULLING COURTS SIDIN 756 S. 10TH POCATELLO, IDA

FLOOR PLANS BUIL

REVISIONS

PROJECT NO. 21001 DATE: AUGUST 2021 DRAWN BY: CHECKED BY:

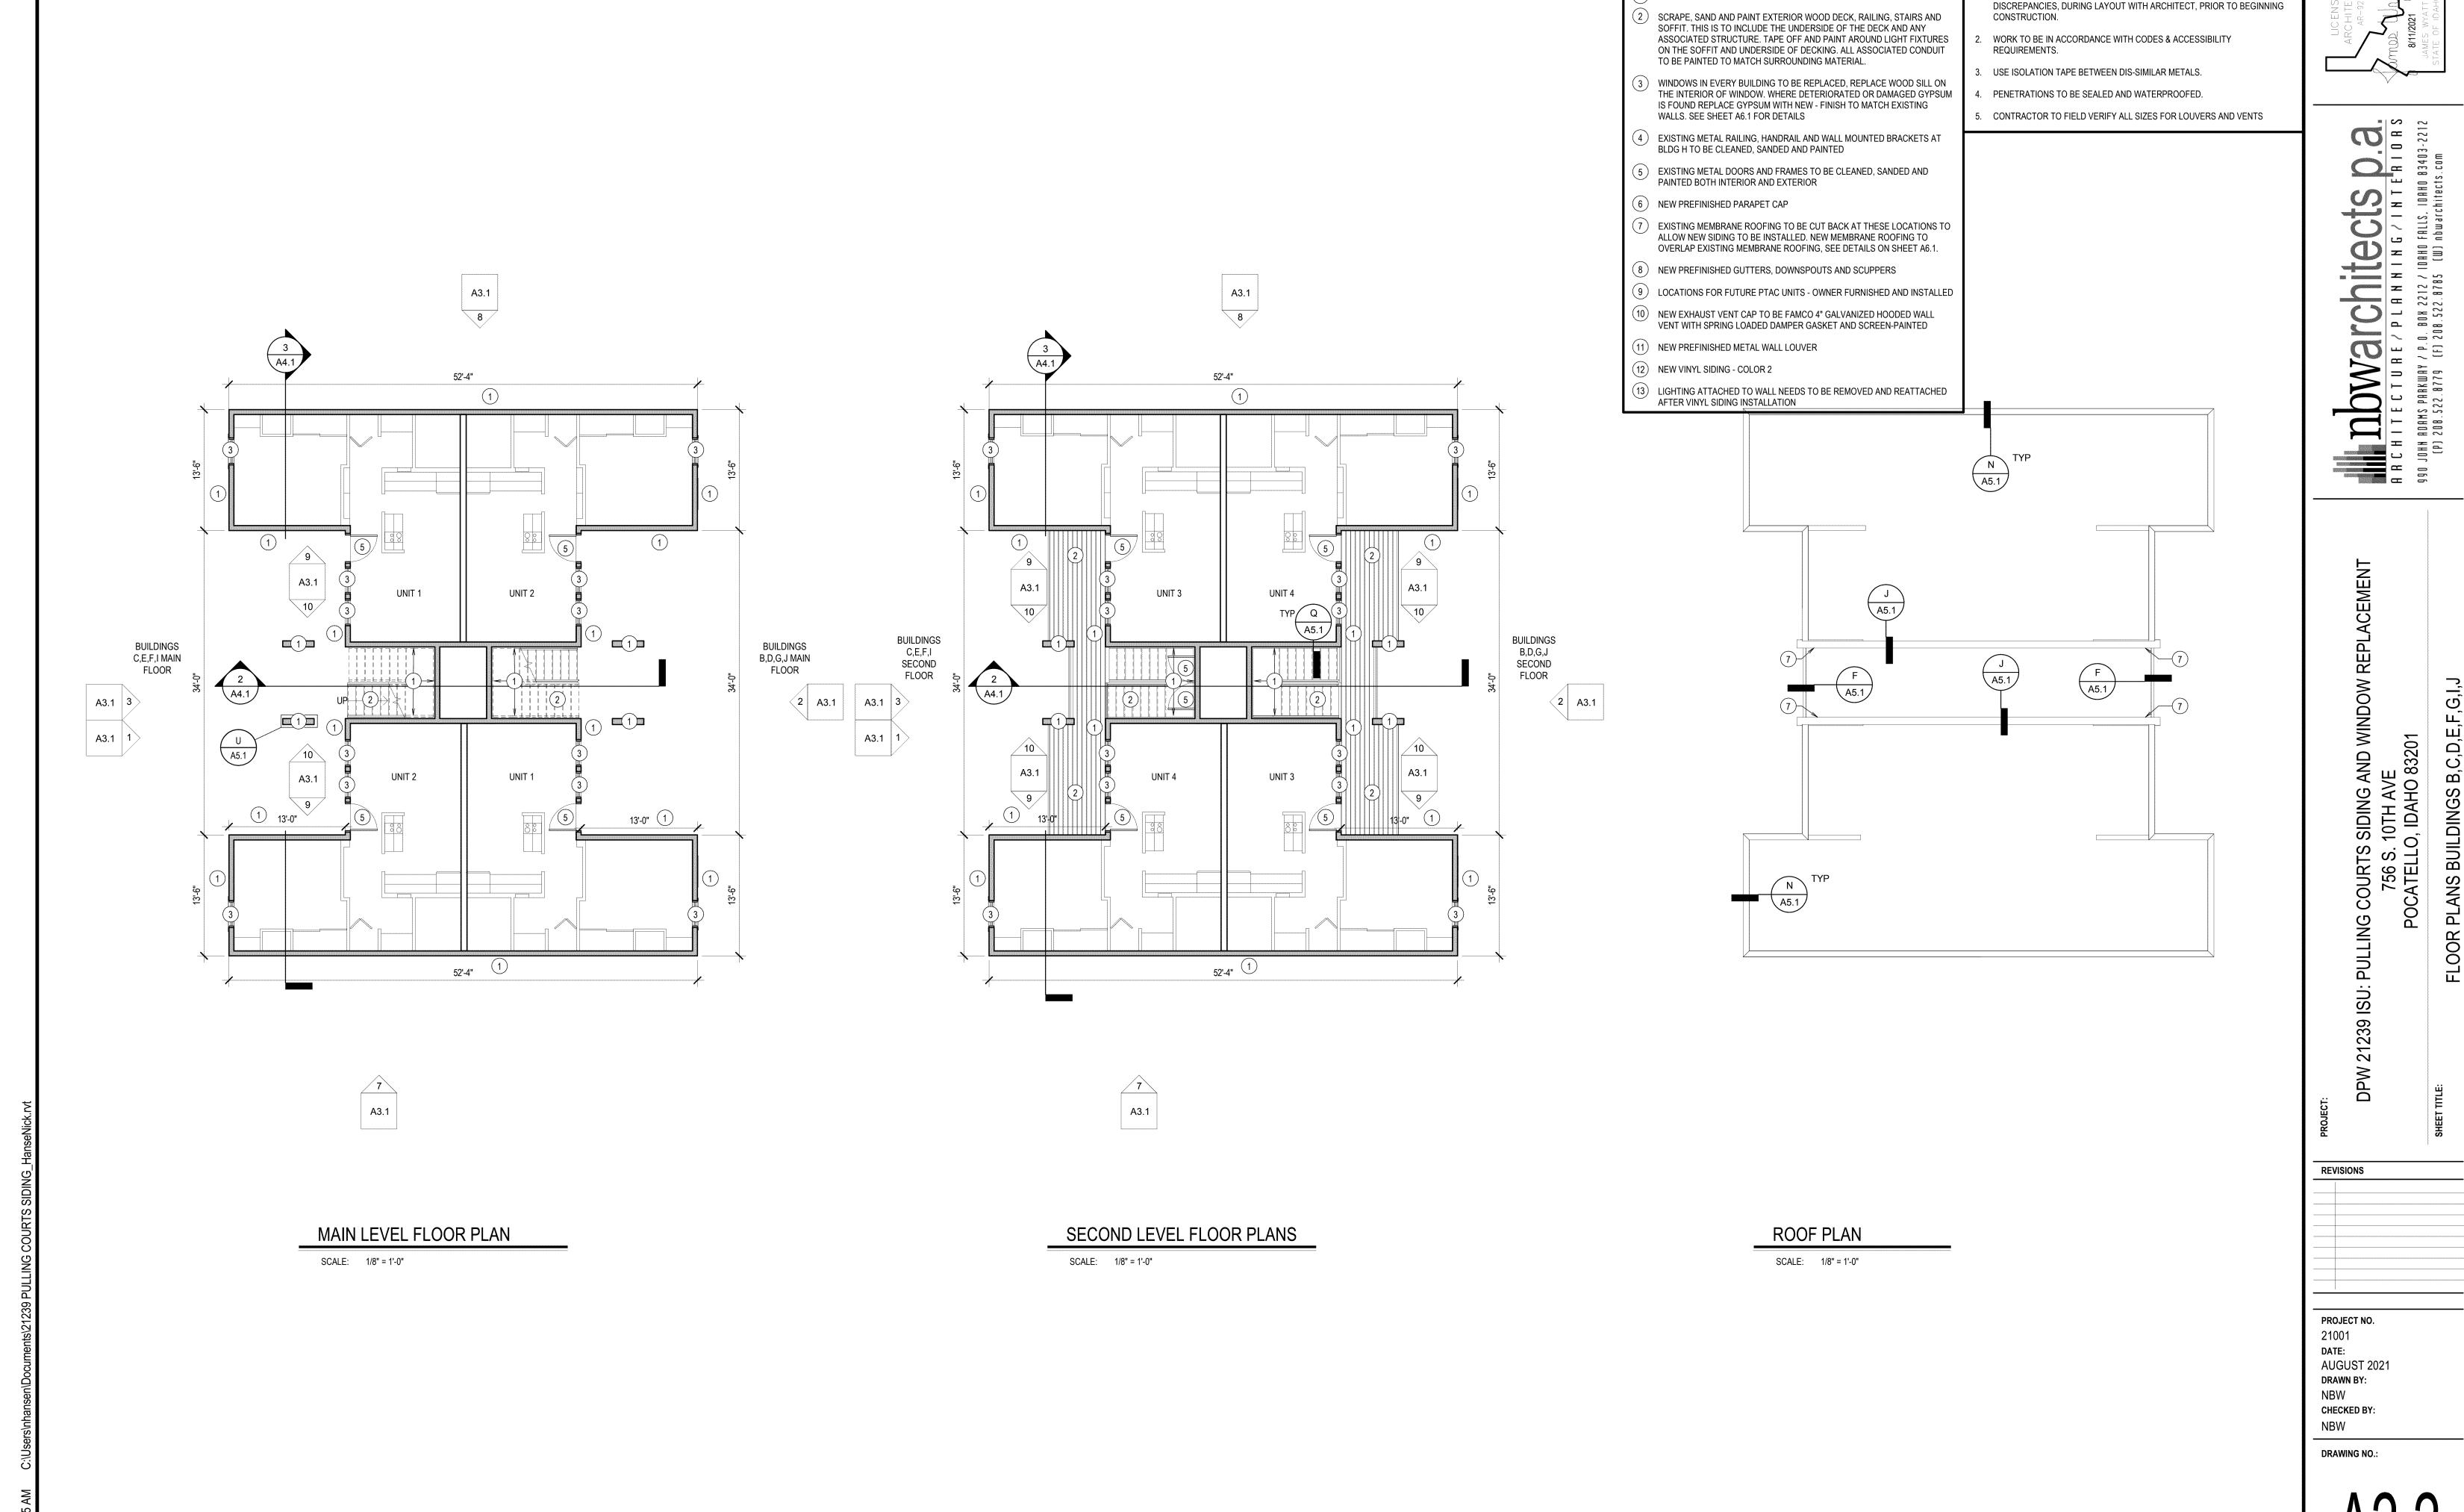


GENERAL NOTES

CONTRACTOR SHALL RESOLVE ALL DIMENSIONAL OR OTHER

KEYNOTES

1) NEW VINYL SIDING - COLOR 1

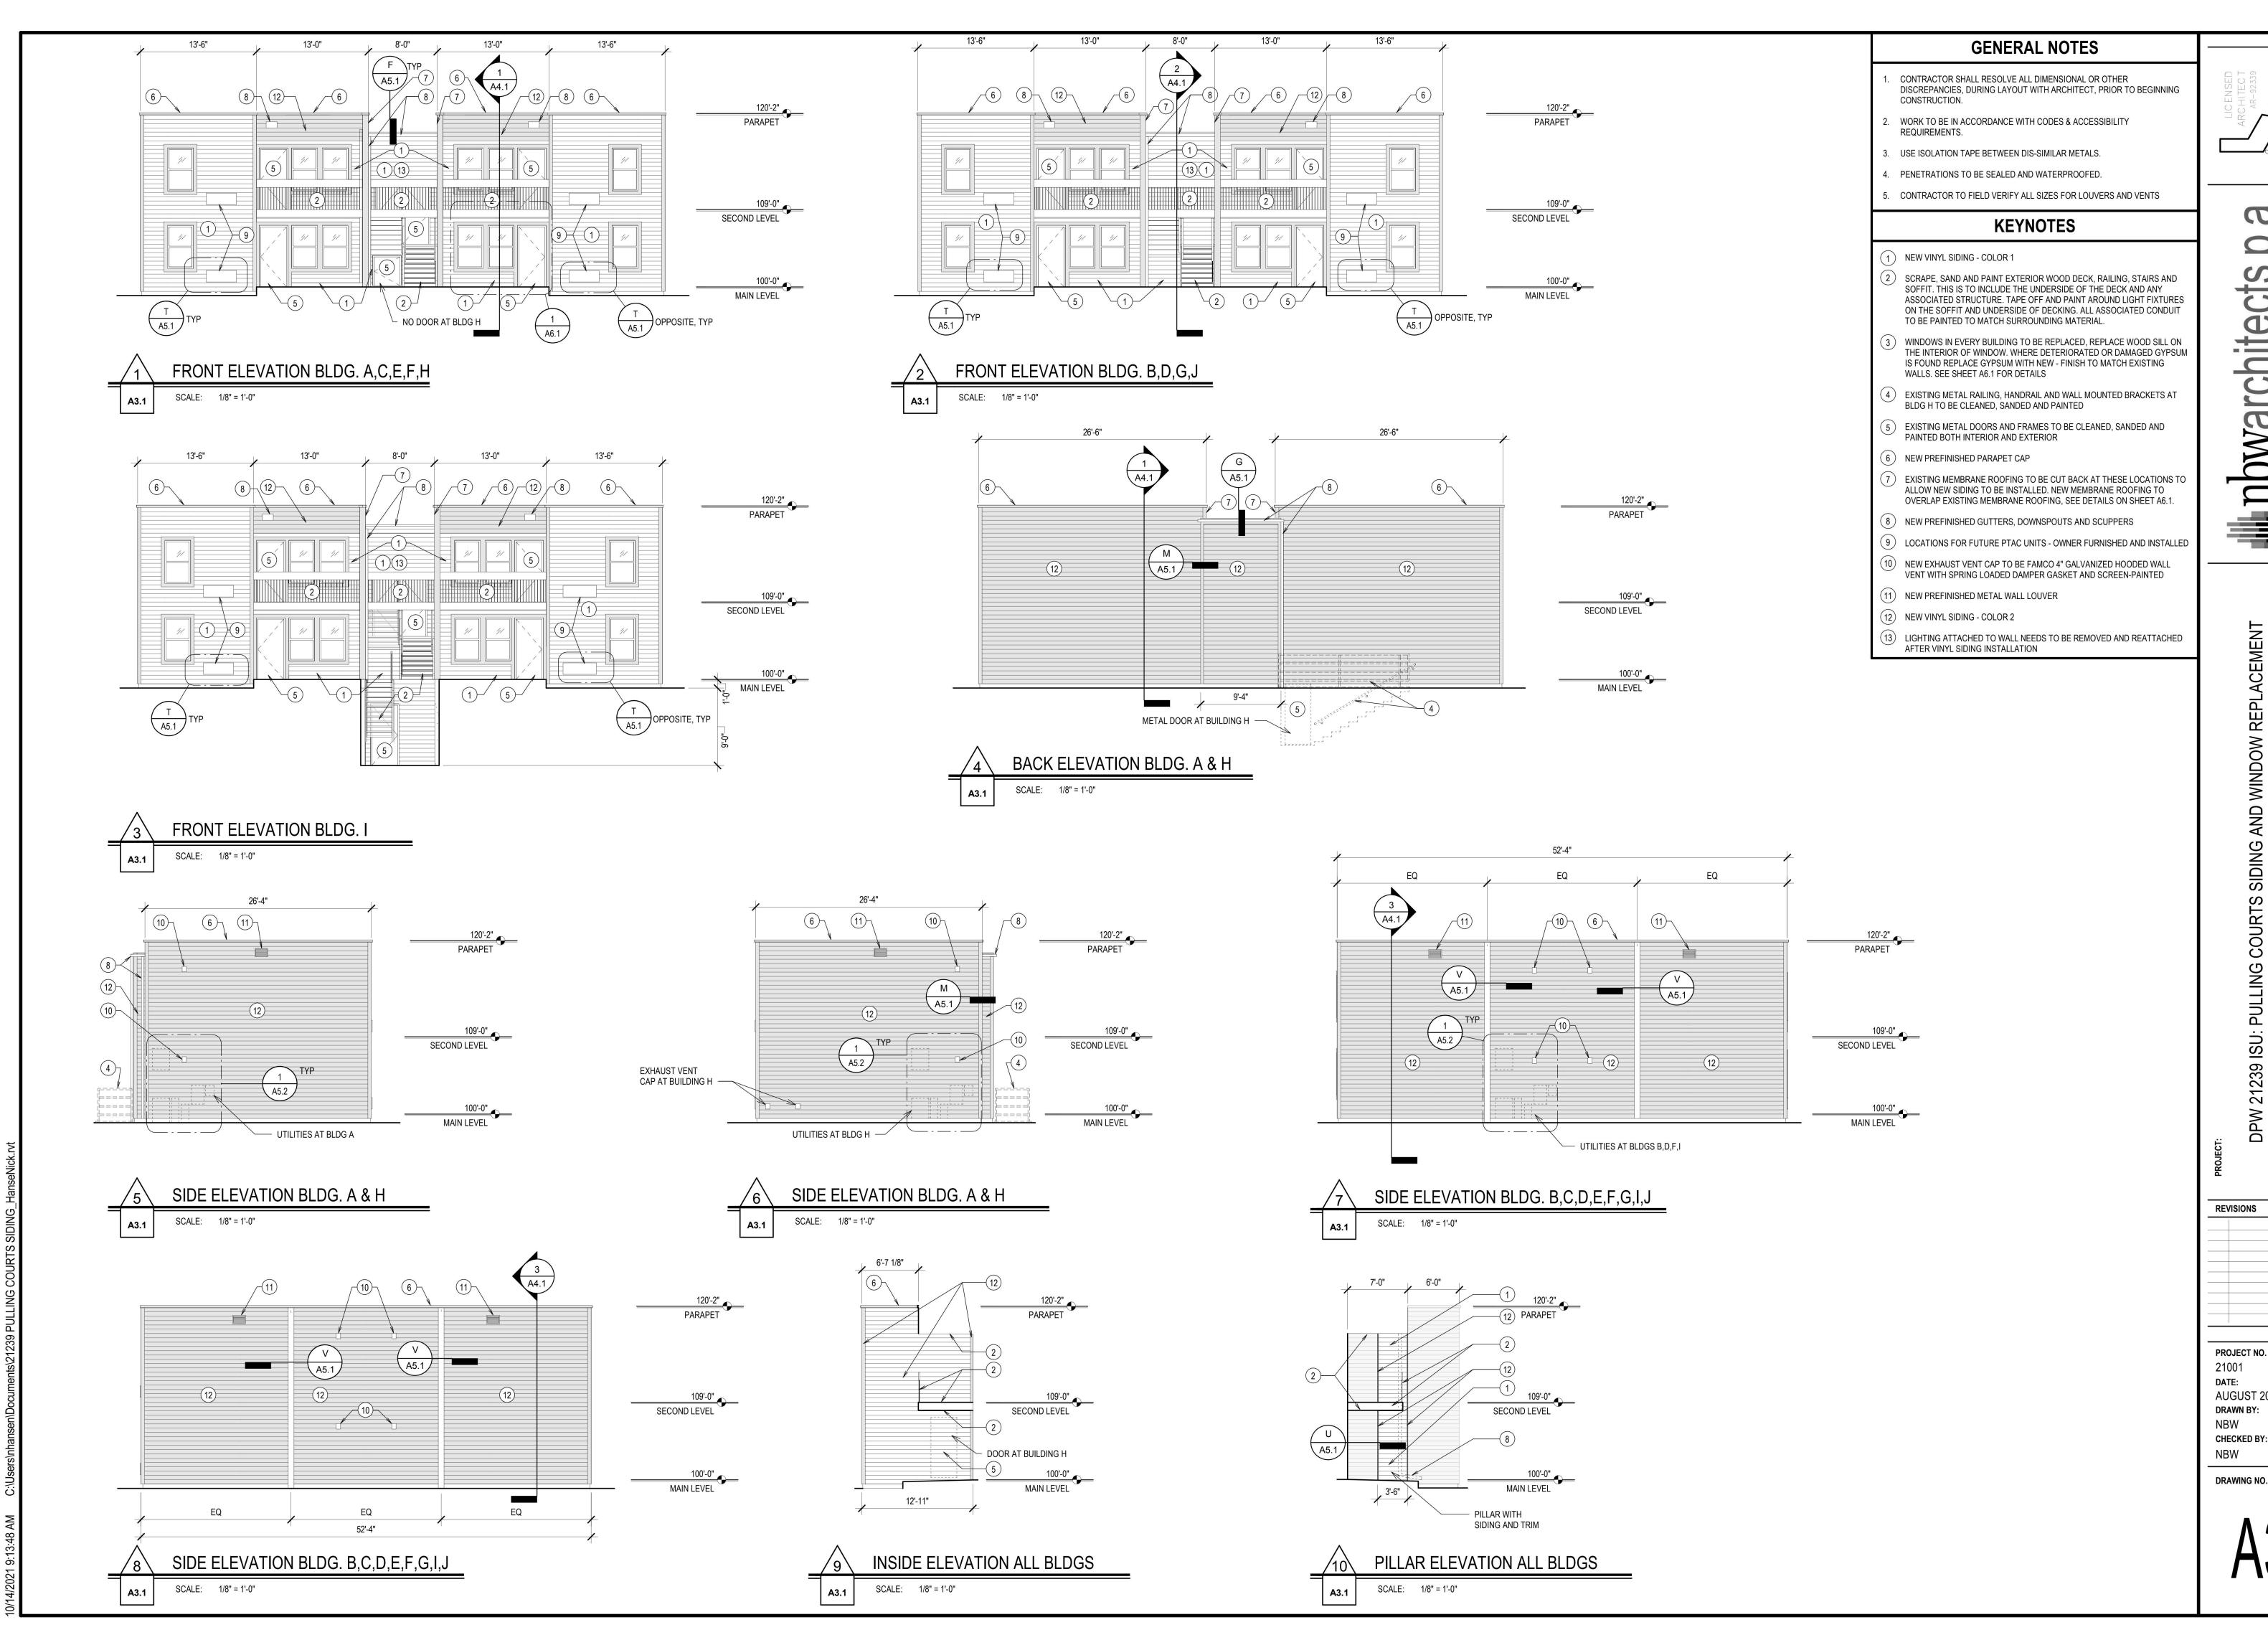


BRCHITECTURE/

1 AVE 4HO 83201

J: PULLING COURTS SIDING 756 S. 10TH A POCATELLO, IDAH

AUGUST 2021

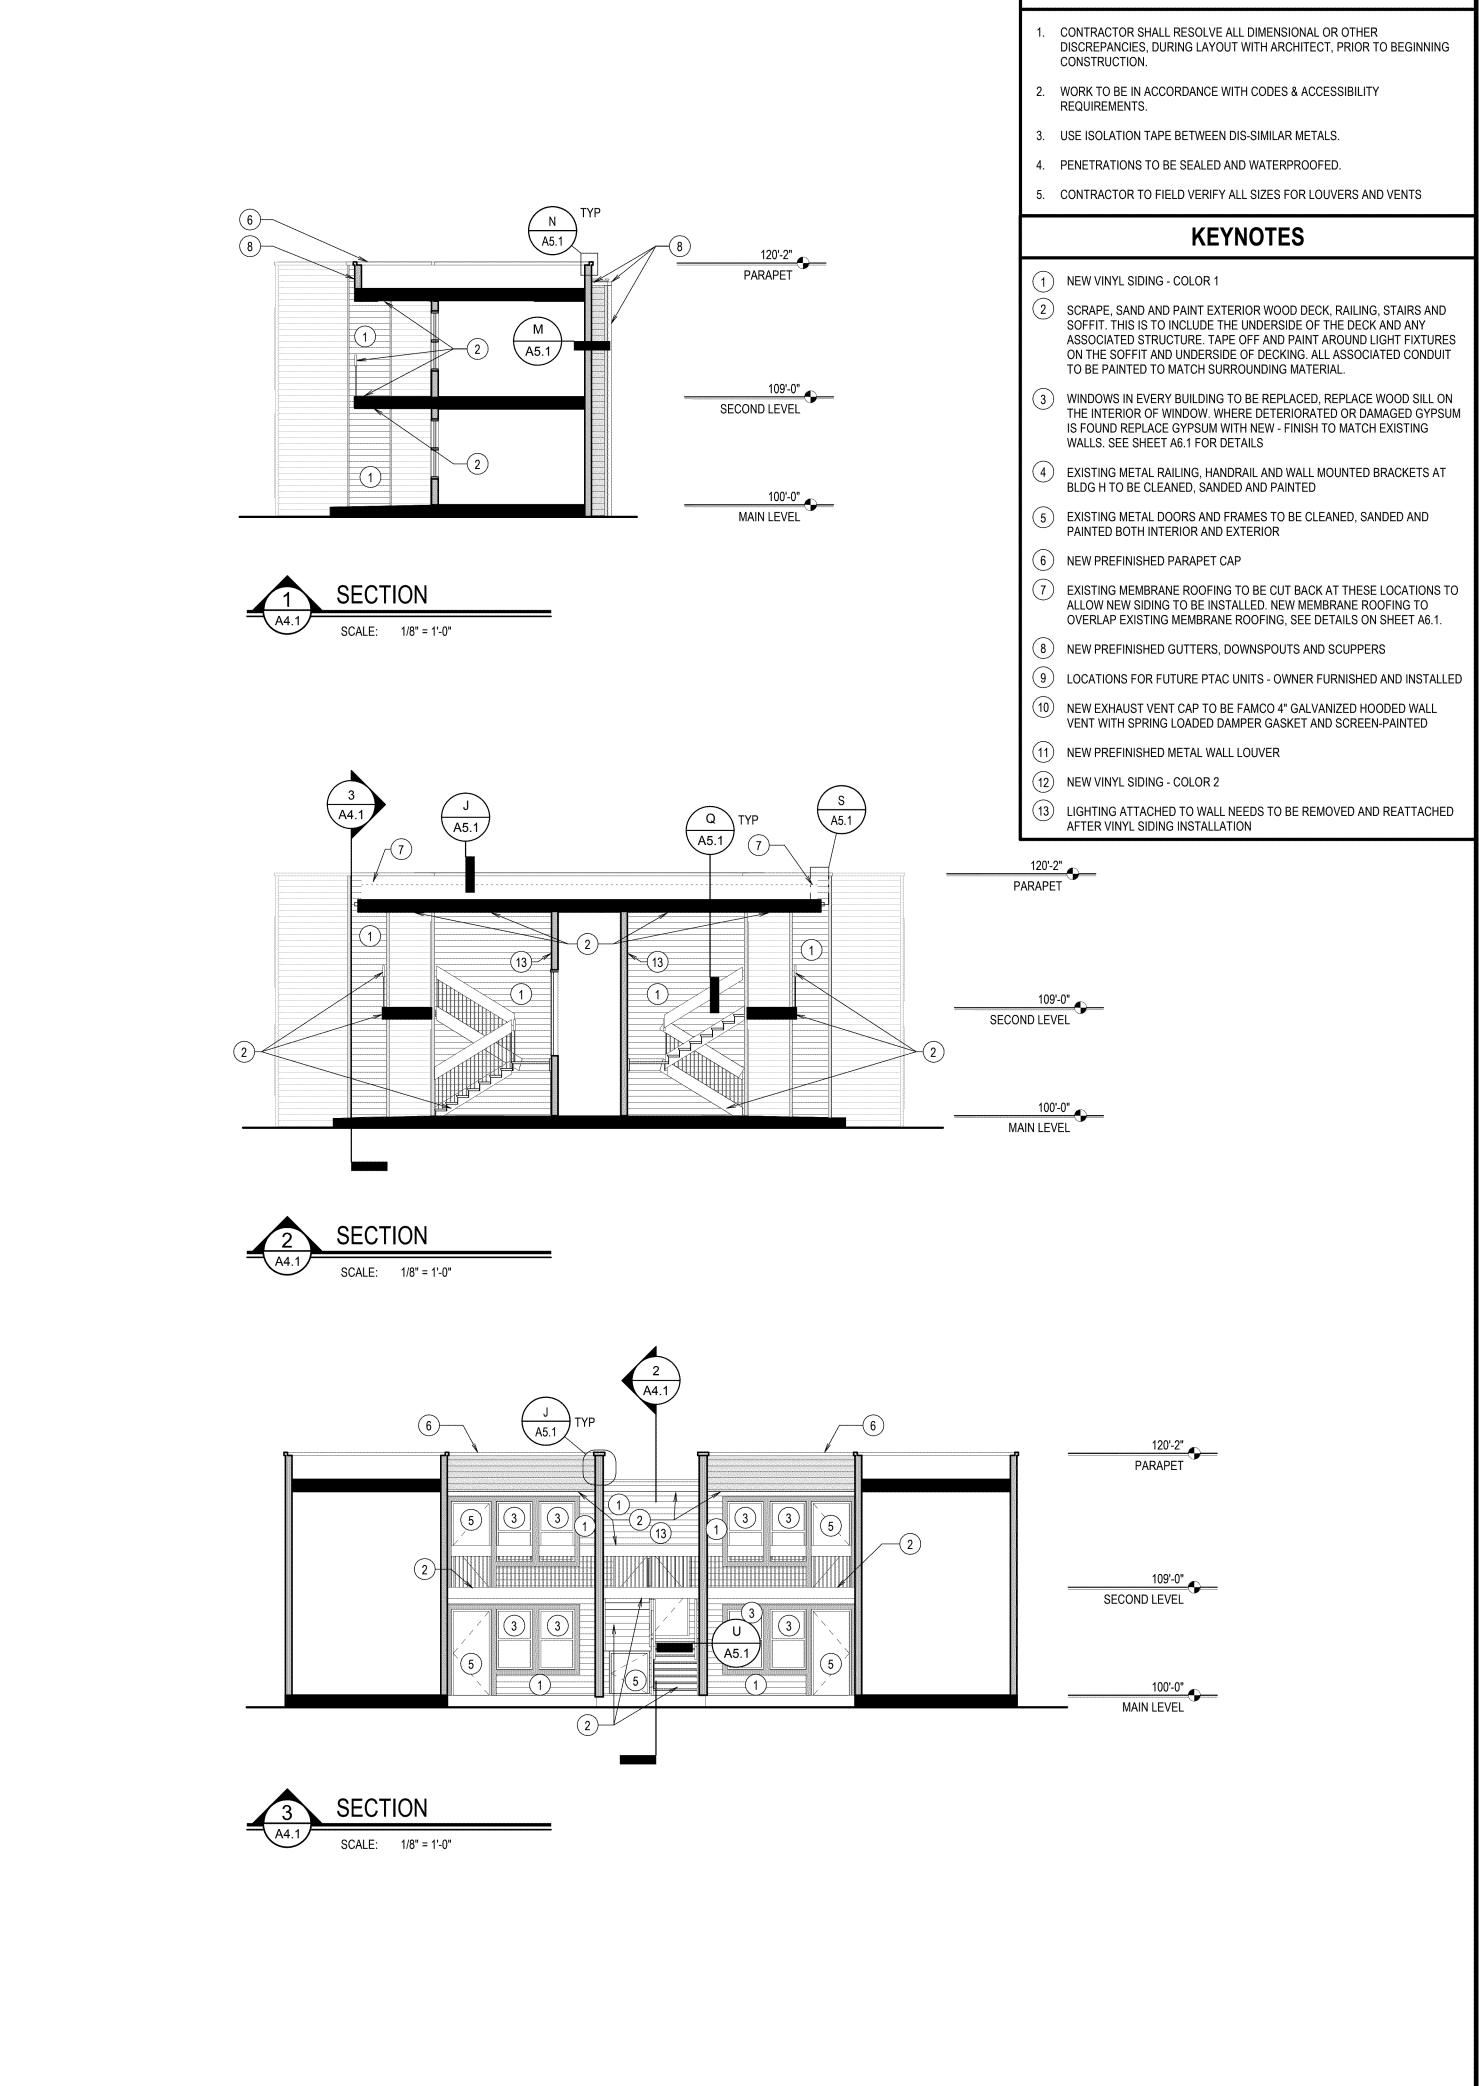

GENERAL NOTES

FILE TURE / PLANNING / INTERIORS 990 JOHN ROAMS PARKWAY / P.O. BOX 2212 / IORHO FALLS, IORHO 83403-2212 (P) 208.522.8779 (F) 208.522.8785 (W) nbwarchitects.com


1 AVE AHO 83201 BUILDING SEC


DPW 21239 ISU: PULLING COURTS SIDIN 756 S. 10TH POCATELLO, IDA

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REVISIONS

PROJECT NO. 21001 DATE: AUGUST 2021 CHECKED BY:



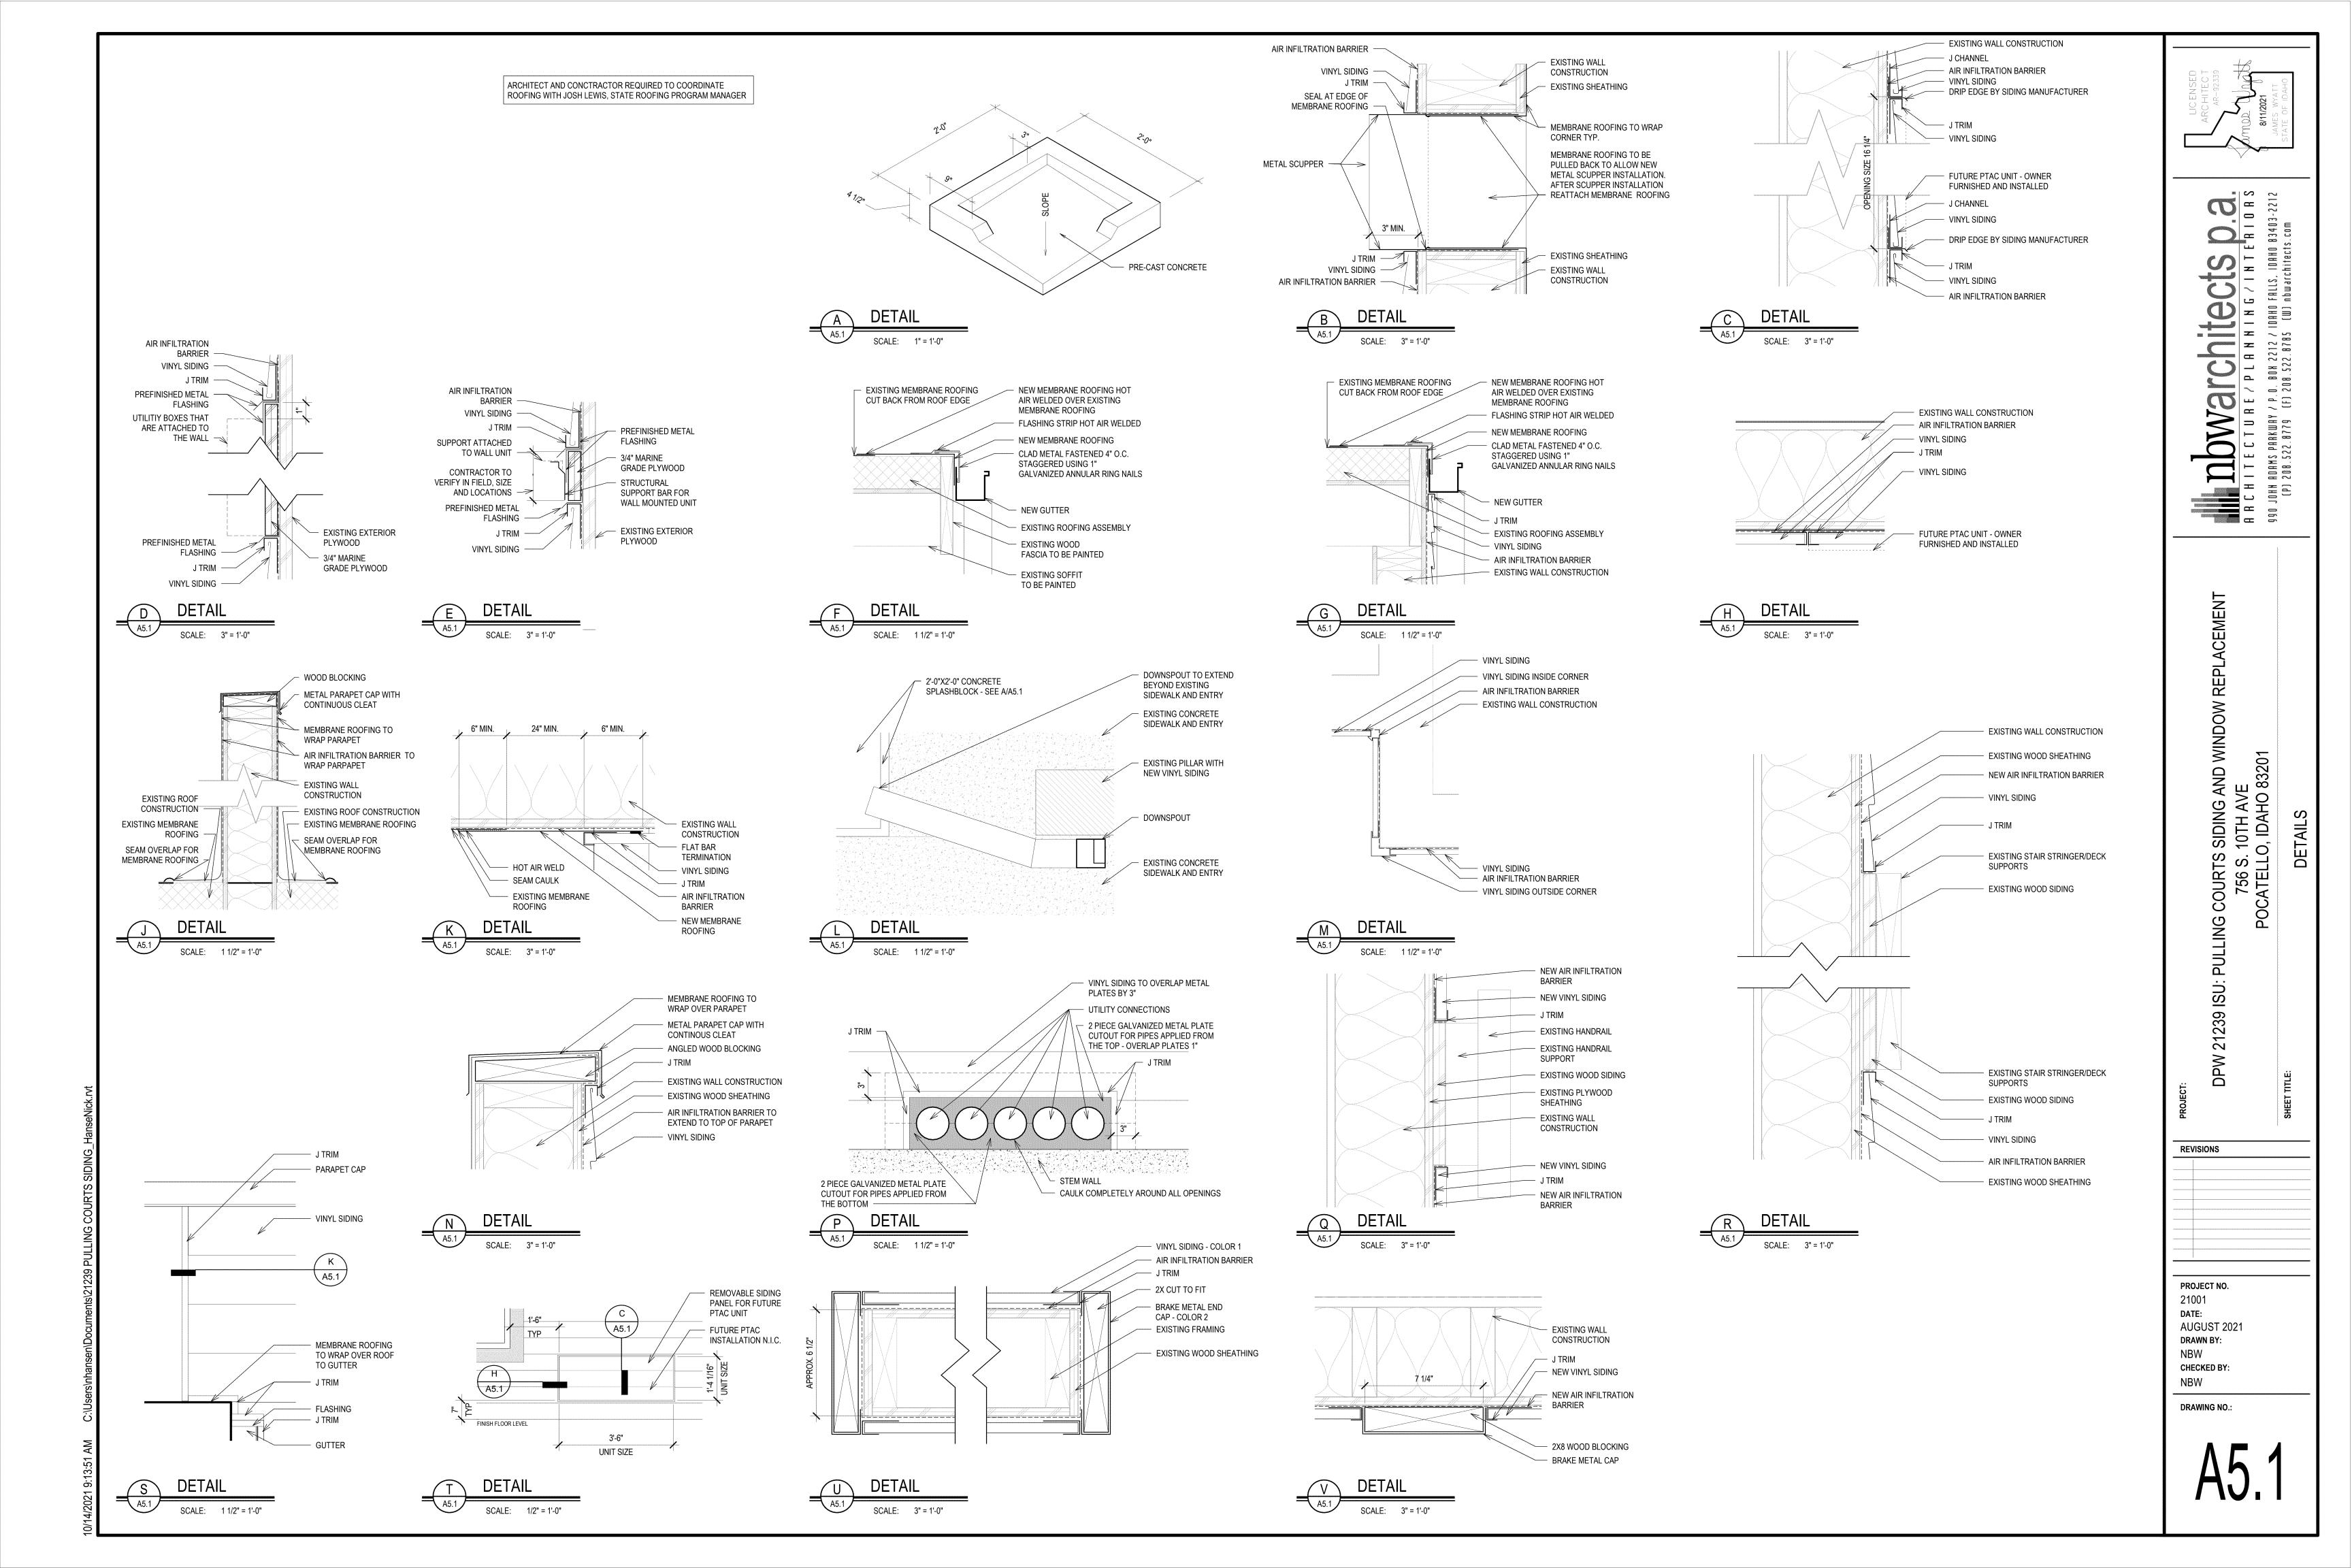

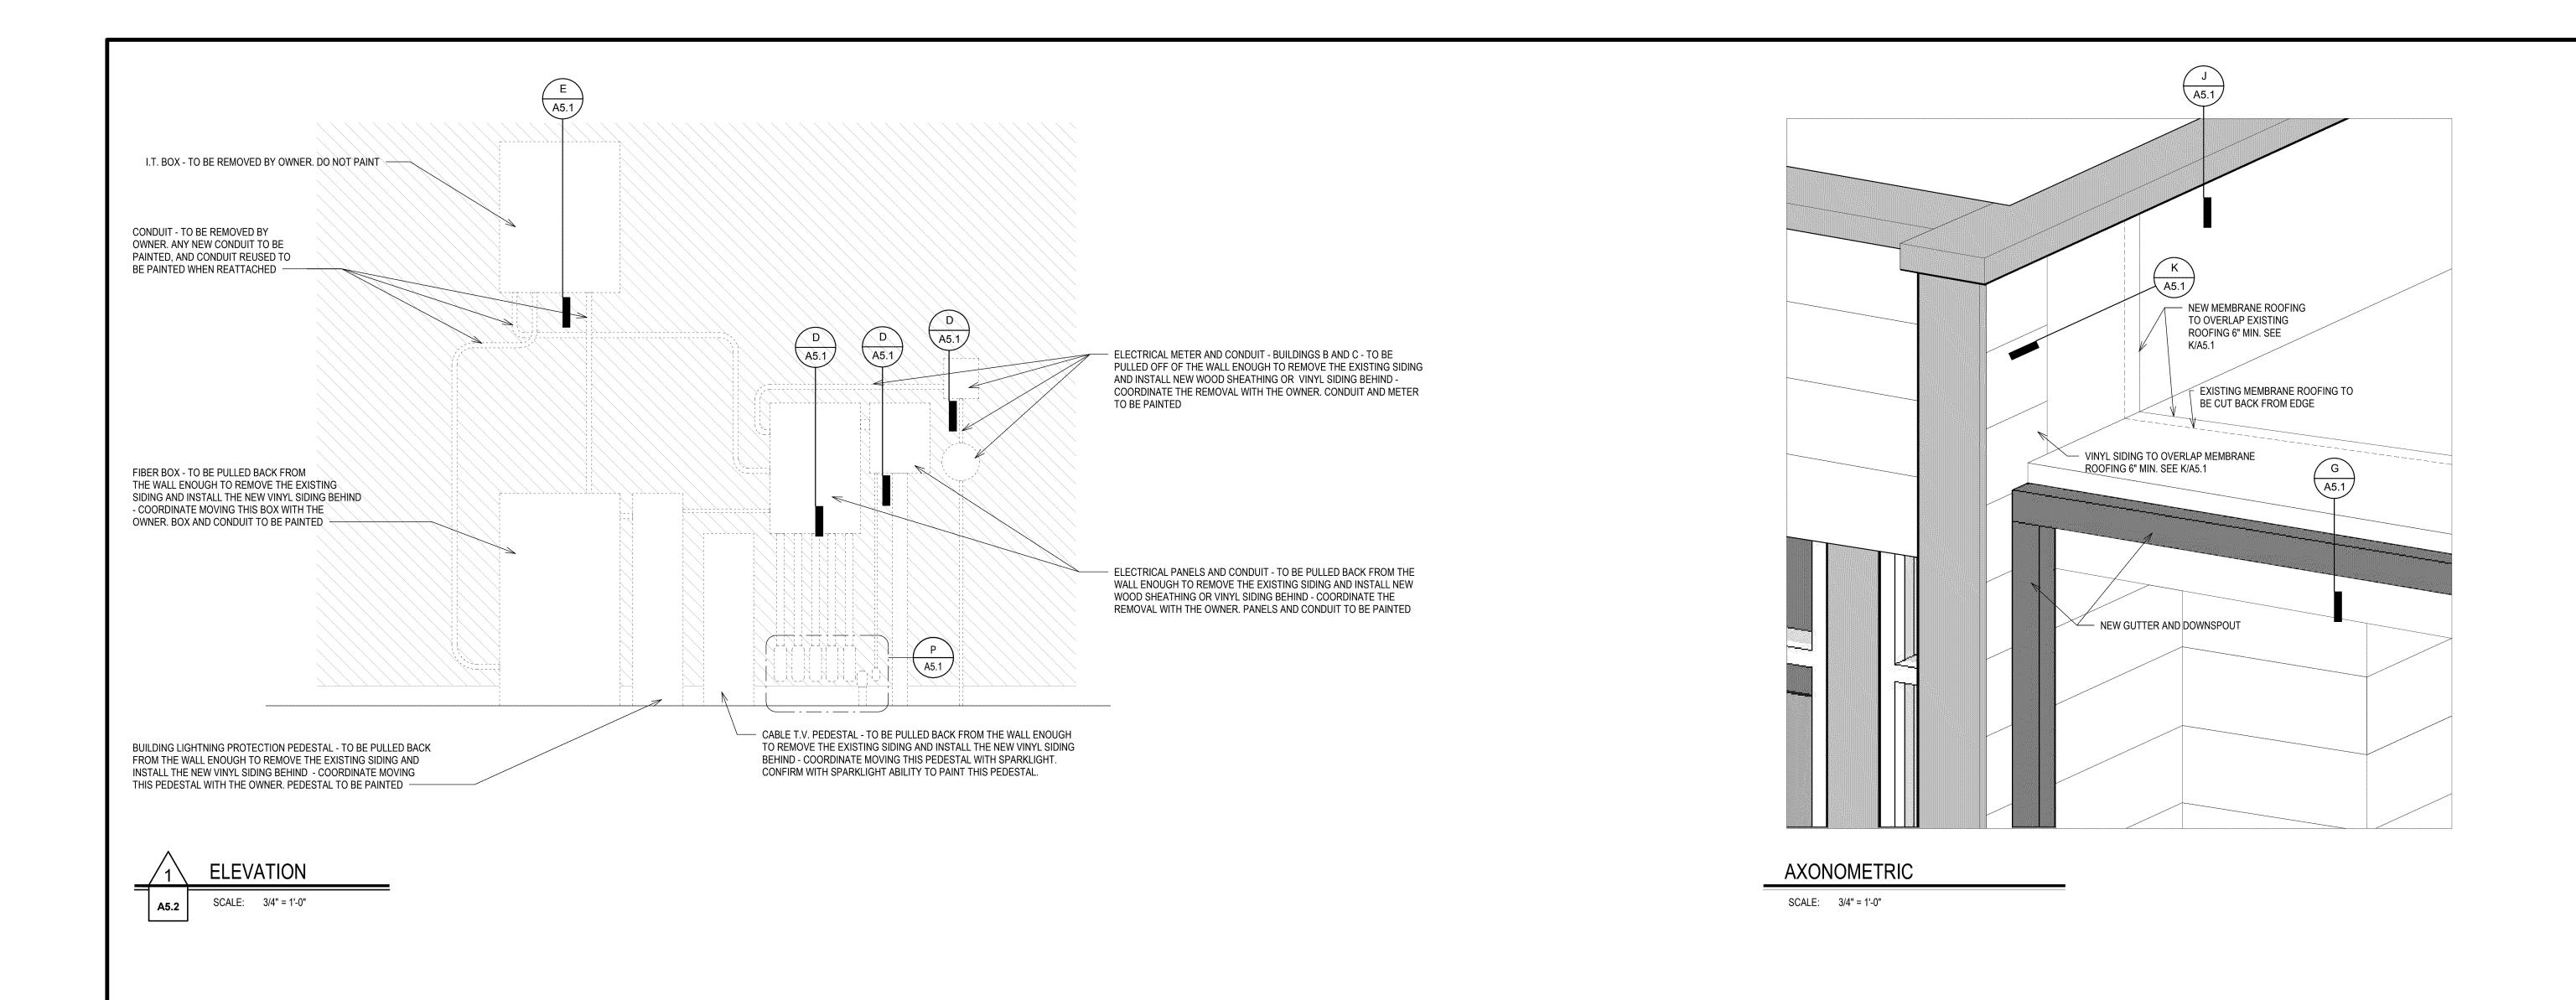
PULLING COURTS SIDING AND WINDOW REPL 756 S. 10TH AVE POCATELLO, IDAHO 83201

DPW 21239 ISU:

PROJECT NO. AUGUST 2021 DRAWN BY:

DRAWING NO.:

CHECKED BY:

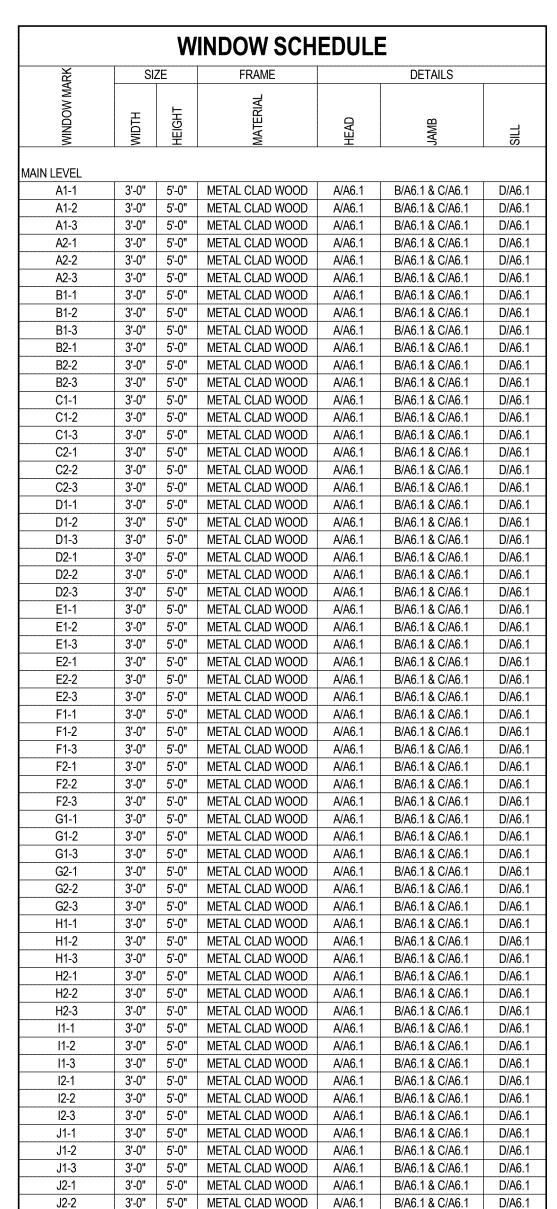

J2-3 3'-0" 5'-0" METAL CLAD WOOD A/A6.1 B/A6.1 & C/A6.1 D/A6.1

		VV	INDOW SCH	ENOF	-	
WINDOW MARK	SI	ZE	FRAME	DETAILS		
₩ ×		,	A			
0	Ӗ	듄	MATERIAL	9	<u>@</u>	,
N X	WIDTH	HEIGHT	MA	HEAD	JAMB	SILL
CECOND LEVE						
SECOND LEVEL A3-1	3'-0"	5'-0"	METAL CLAD WOOD	A/A6.1	B/A6.1 & C/A6.1	D/A6.
A3-1 A3-2	3'-0"	5'-0"	METAL CLAD WOOD	A/A6.1	B/A6.1 & C/A6.1	D/A6.
A3-2 A3-3	3'-0"	5'-0"	METAL CLAD WOOD	A/A6.1	B/A6.1 & C/A6.1	D/A6.
A4-1	3'-0"	5'-0"	METAL CLAD WOOD	A/A6.1	B/A6.1 & C/A6.1	D/A6.
A4-1	3'-0"	5'-0"	METAL CLAD WOOD	A/A6.1	B/A6.1 & C/A6.1	D/A6.
A4-3	3'-0"	5'-0"	METAL CLAD WOOD	A/A6.1	B/A6.1 & C/A6.1	D/A6.
B3-1	3'-0"	5'-0"	METAL CLAD WOOD	A/A6.1	B/A6.1 & C/A6.1	D/A6.
B3-2	3'-0"	5'-0"	METAL CLAD WOOD	A/A6.1	B/A6.1 & C/A6.1	D/A6.
B3-3	3'-0"	5'-0"	METAL CLAD WOOD	A/A6.1	B/A6.1 & C/A6.1	D/A6.
B4-1	3'-0"	5'-0"	METAL CLAD WOOD	A/A6.1	B/A6.1 & C/A6.1	D/A6.
B4-2	3'-0"	5'-0"	METAL CLAD WOOD	A/A6.1	B/A6.1 & C/A6.1	D/A6.
B4-3	3'-0"	5'-0"	METAL CLAD WOOD	A/A6.1	B/A6.1 & C/A6.1	D/A6.
C3-1	3'-0"	5'-0"	METAL CLAD WOOD	A/A6.1	B/A6.1 & C/A6.1	D/A6.
C3-2	3'-0"	5'-0"	METAL CLAD WOOD	A/A6.1	B/A6.1 & C/A6.1	D/A6.
C3-3	3'-0"	5'-0"	METAL CLAD WOOD	A/A6.1	B/A6.1 & C/A6.1	D/A6.
C4-1	3'-0"	5'-0"	METAL CLAD WOOD	A/A6.1	B/A6.1 & C/A6.1	D/A6.
C4-2	3'-0"	5'-0"	METAL CLAD WOOD	A/A6.1	B/A6.1 & C/A6.1	D/A6.
C4-3	3'-0"	5'-0"	METAL CLAD WOOD	A/A6.1	B/A6.1 & C/A6.1	D/A6.
D3-1	3'-0"	5'-0"	METAL CLAD WOOD	A/A6.1	B/A6.1 & C/A6.1	D/A6.
D3-2	3'-0"	5'-0"	METAL CLAD WOOD	A/A6.1	B/A6.1 & C/A6.1	D/A6.
D3-3	3'-0"	5'-0"	METAL CLAD WOOD	A/A6.1	B/A6.1 & C/A6.1	D/A6.
D4-1	3'-0"	5'-0"	METAL CLAD WOOD	A/A6.1	B/A6.1 & C/A6.1	D/A6.
D4-2	3'-0"	5'-0"	METAL CLAD WOOD	A/A6.1	B/A6.1 & C/A6.1	D/A6.
D4-3	3'-0"	5'-0"	METAL CLAD WOOD	A/A6.1	B/A6.1 & C/A6.1	D/A6.
E3-1	3'-0"	5'-0"	METAL CLAD WOOD	A/A6.1	B/A6.1 & C/A6.1	D/A6.
E3-2	3'-0"	5'-0"	METAL CLAD WOOD	A/A6.1	B/A6.1 & C/A6.1	D/A6.
E3-3	3'-0"	5'-0"	METAL CLAD WOOD	A/A6.1	B/A6.1 & C/A6.1	D/A6.
E4-1	3'-0"	5'-0"	METAL CLAD WOOD	A/A6.1	B/A6.1 & C/A6.1	D/A6.
E4-2	3'-0"	5'-0"	METAL CLAD WOOD	A/A6.1	B/A6.1 & C/A6.1	D/A6.
E4-3	3'-0"	5'-0"	METAL CLAD WOOD	A/A6.1	B/A6.1 & C/A6.1	D/A6.
F3-1	3'-0"	5'-0"	METAL CLAD WOOD	A/A6.1	B/A6.1 & C/A6.1	D/A6.
F3-2	3'-0"	5'-0"	METAL CLAD WOOD	A/A6.1	B/A6.1 & C/A6.1	D/A6.
F3-3	3'-0"	5'-0"	METAL CLAD WOOD	A/A6.1	B/A6.1 & C/A6.1	D/A6.
F4-1	3'-0"	5'-0"	METAL CLAD WOOD	A/A6.1	B/A6.1 & C/A6.1	D/A6.
F4-2	3'-0"	5'-0"	METAL CLAD WOOD	A/A6.1	B/A6.1 & C/A6.1	D/A6.
F4-3	3'-0"	5'-0"	METAL CLAD WOOD	A/A6.1	B/A6.1 & C/A6.1	D/A6.
G3-1	3'-0"	5'-0"	METAL CLAD WOOD	A/A6.1	B/A6.1 & C/A6.1	D/A6.
G3-2	3'-0"	5'-0"	METAL CLAD WOOD	A/A6.1	B/A6.1 & C/A6.1	D/A6.
G3-3	3'-0"	5'-0"	METAL CLAD WOOD	A/A6.1	B/A6.1 & C/A6.1	D/A6.
G4-1	3'-0"	5'-0"	METAL CLAD WOOD	A/A6.1	B/A6.1 & C/A6.1	D/A6.
G4-2	3'-0"	5'-0"	METAL CLAD WOOD	A/A6.1	B/A6.1 & C/A6.1	D/A6.
G4-3	3'-0"	5'-0"	METAL CLAD WOOD	A/A6.1	B/A6.1 & C/A6.1	D/A6.
H3-1	3'-0"	5'-0"	METAL CLAD WOOD	A/A6.1	B/A6.1 & C/A6.1	D/A6.
H3-2	3'-0"	5'-0"	METAL CLAD WOOD	A/A6.1	B/A6.1 & C/A6.1	D/A6.
H3-3	3'-0"	5'-0"	METAL CLAD WOOD	A/A6.1	B/A6.1 & C/A6.1	D/A6.
H4-1	3'-0"	5'-0"	METAL CLAD WOOD	A/A6.1	B/A6.1 & C/A6.1	D/A6.
H4-2	3'-0"	5'-0"	METAL CLAD WOOD	A/A6.1	B/A6.1 & C/A6.1	D/A6.
H4-3	3'-0"	5'-0"	METAL CLAD WOOD	A/A6.1	B/A6.1 & C/A6.1	D/A6.
I3-1	3'-0"	5'-0"	METAL CLAD WOOD	A/A6.1	B/A6.1 & C/A6.1	D/A6.
13-2	3'-0"	5'-0"	METAL CLAD WOOD	A/A6.1	B/A6.1 & C/A6.1	D/A6.
13-3	3'-0"	5'-0"	METAL CLAD WOOD	A/A6.1	B/A6.1 & C/A6.1	D/A6.
I4-1	3'-0"	5'-0"	METAL CLAD WOOD	A/A6.1	B/A6.1 & C/A6.1	D/A6.
14-2	3'-0"	5'-0"	METAL CLAD WOOD	A/A6.1	B/A6.1 & C/A6.1	D/A6.
14-3	3'-0"	5'-0"	METAL CLAD WOOD	A/A6.1	B/A6.1 & C/A6.1	D/A6.
J3-1	3'-0"	5'-0"	METAL CLAD WOOD	A/A6.1	B/A6.1 & C/A6.1	D/A6.
J3-2	3'-0"	5'-0"	METAL CLAD WOOD	A/A6.1	B/A6.1 & C/A6.1	D/A6.
J3-3	3'-0"	5'-0"	METAL CLAD WOOD	A/A6.1	B/A6.1 & C/A6.1	D/A6.
J4-1	3'-0"	5'-0"	METAL CLAD WOOD	A/A6.1	B/A6.1 & C/A6.1	D/A6.
J4-2	3'-0"	5'-0"	METAL CLAD WOOD	A/A6.1	B/A6.1 & C/A6.1	D/A6.
1/1/2	ייח יב	5' 0"	METAL CLAD WOOD	A / A G 4	DIAC 4 9 CIAC 4	D/A6

J4-3 3'-0" 5'-0" METAL CLAD WOOD A/A6.1 B/A6.1 & C/A6.1 D/A6.1




BUILDING CALLOUT (A-J)

WINDOW NUMBERING TYP ALL BLDGS

SCALE: 1/8" = 1'-0"

A6.1

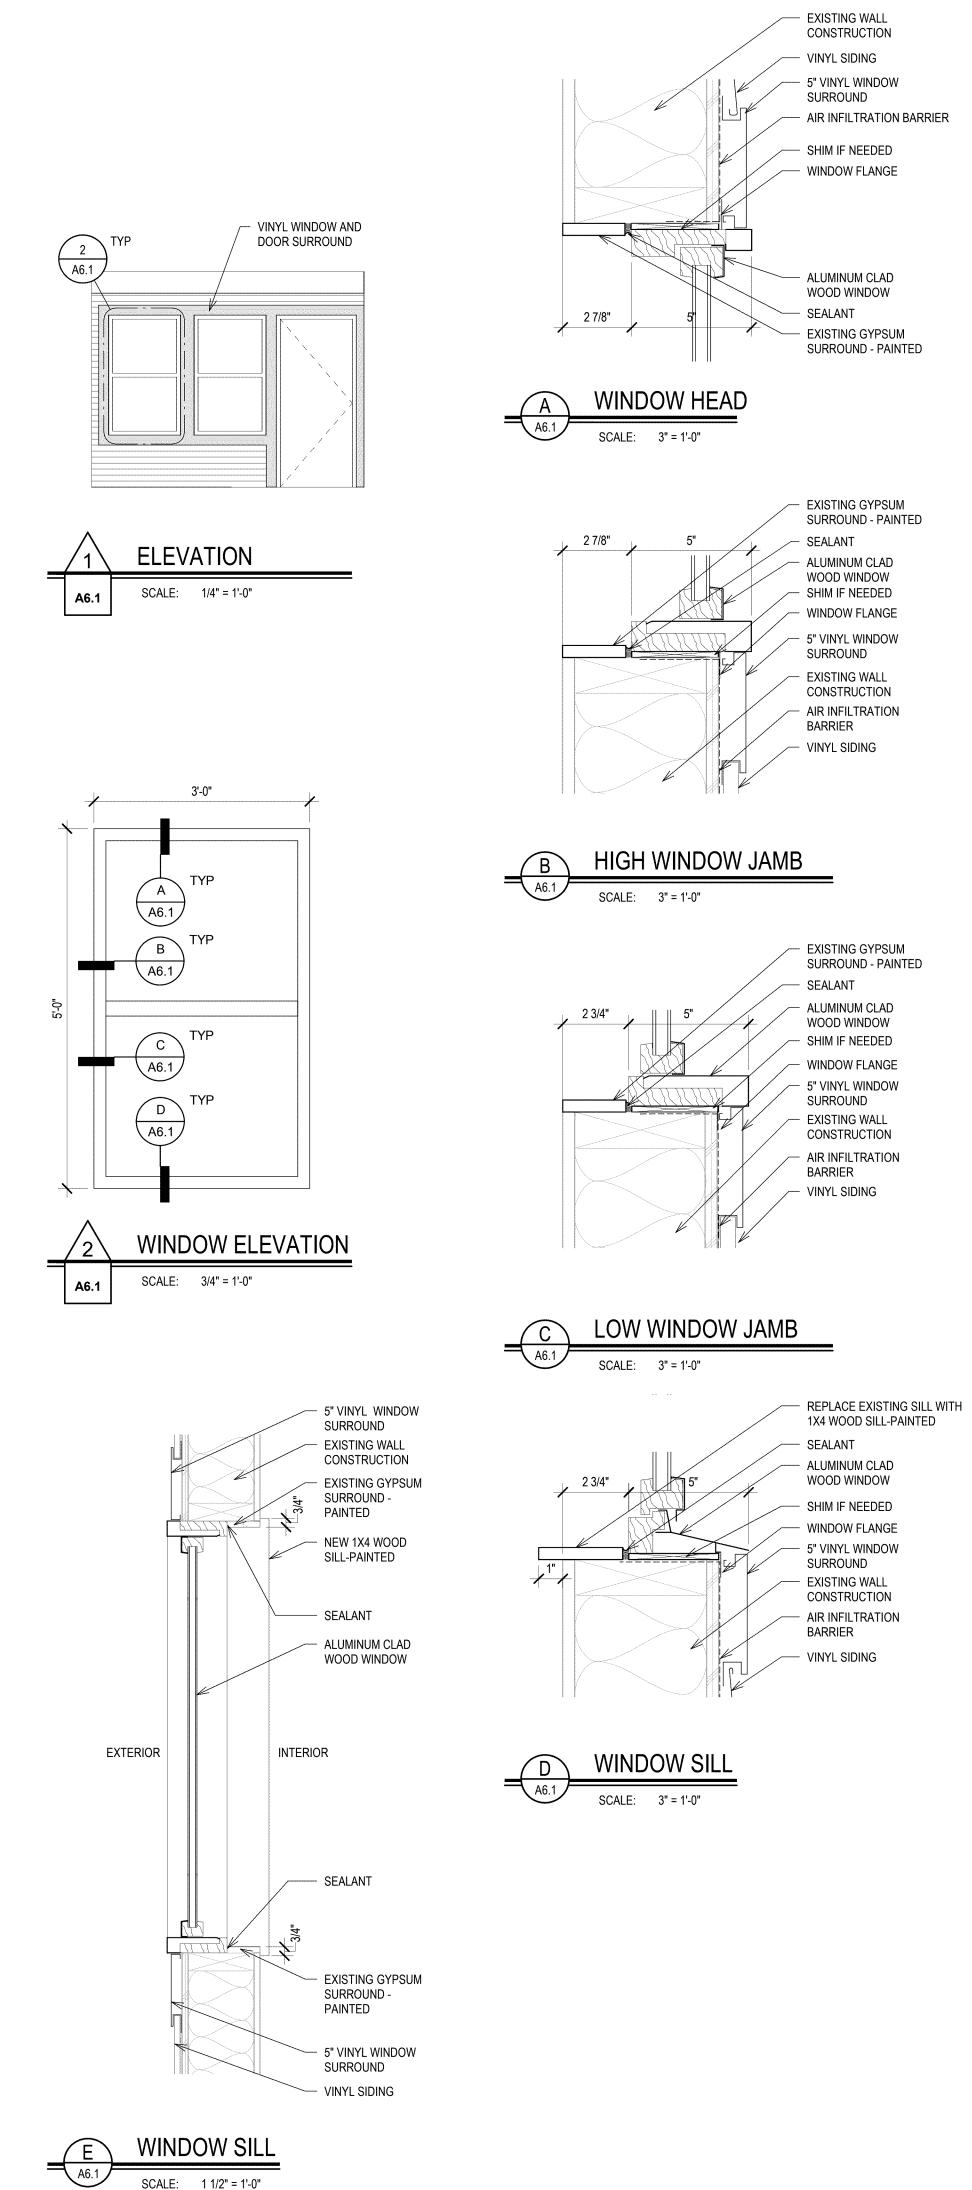

ACEMENT

R C H I T E C T U R E / P L R N H I N G / I N T 920 JOHN RORMS PRRKWRY / P.O. BON 2272 / 108H0 FALLS, 108 (P) 208-522-8779 (F) 208-522-8785 (W) nbwarchite

REPL

: PULLING COURTS SIDING AND WINDOW 756 S. 10TH AVE POCATELLO, IDAHO 83201

V 21239 ISU: PULLING COU

DPW 2

REVISIONS

PROJECT NO.
21001
DATE:
AUGUST 2021
DRAWN BY:
NBW
CHECKED BY:

NBW

DRAWING NO.:

A6.1